GENERAL ARRANGEMENT DRAWINGS



ALL IN! EDMONTON 2014

ISSUED FOR CONSTRUCTION & BUILDING PERMIT

MAY 2014



CONTRACTORS:



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Read Jones Christoffersen

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DRAWING LIST - LANDSCAPE

L2 LANDSCAPE PLAN

L1 LANDSCAPE SPECIFICATIONS AND DETAILS





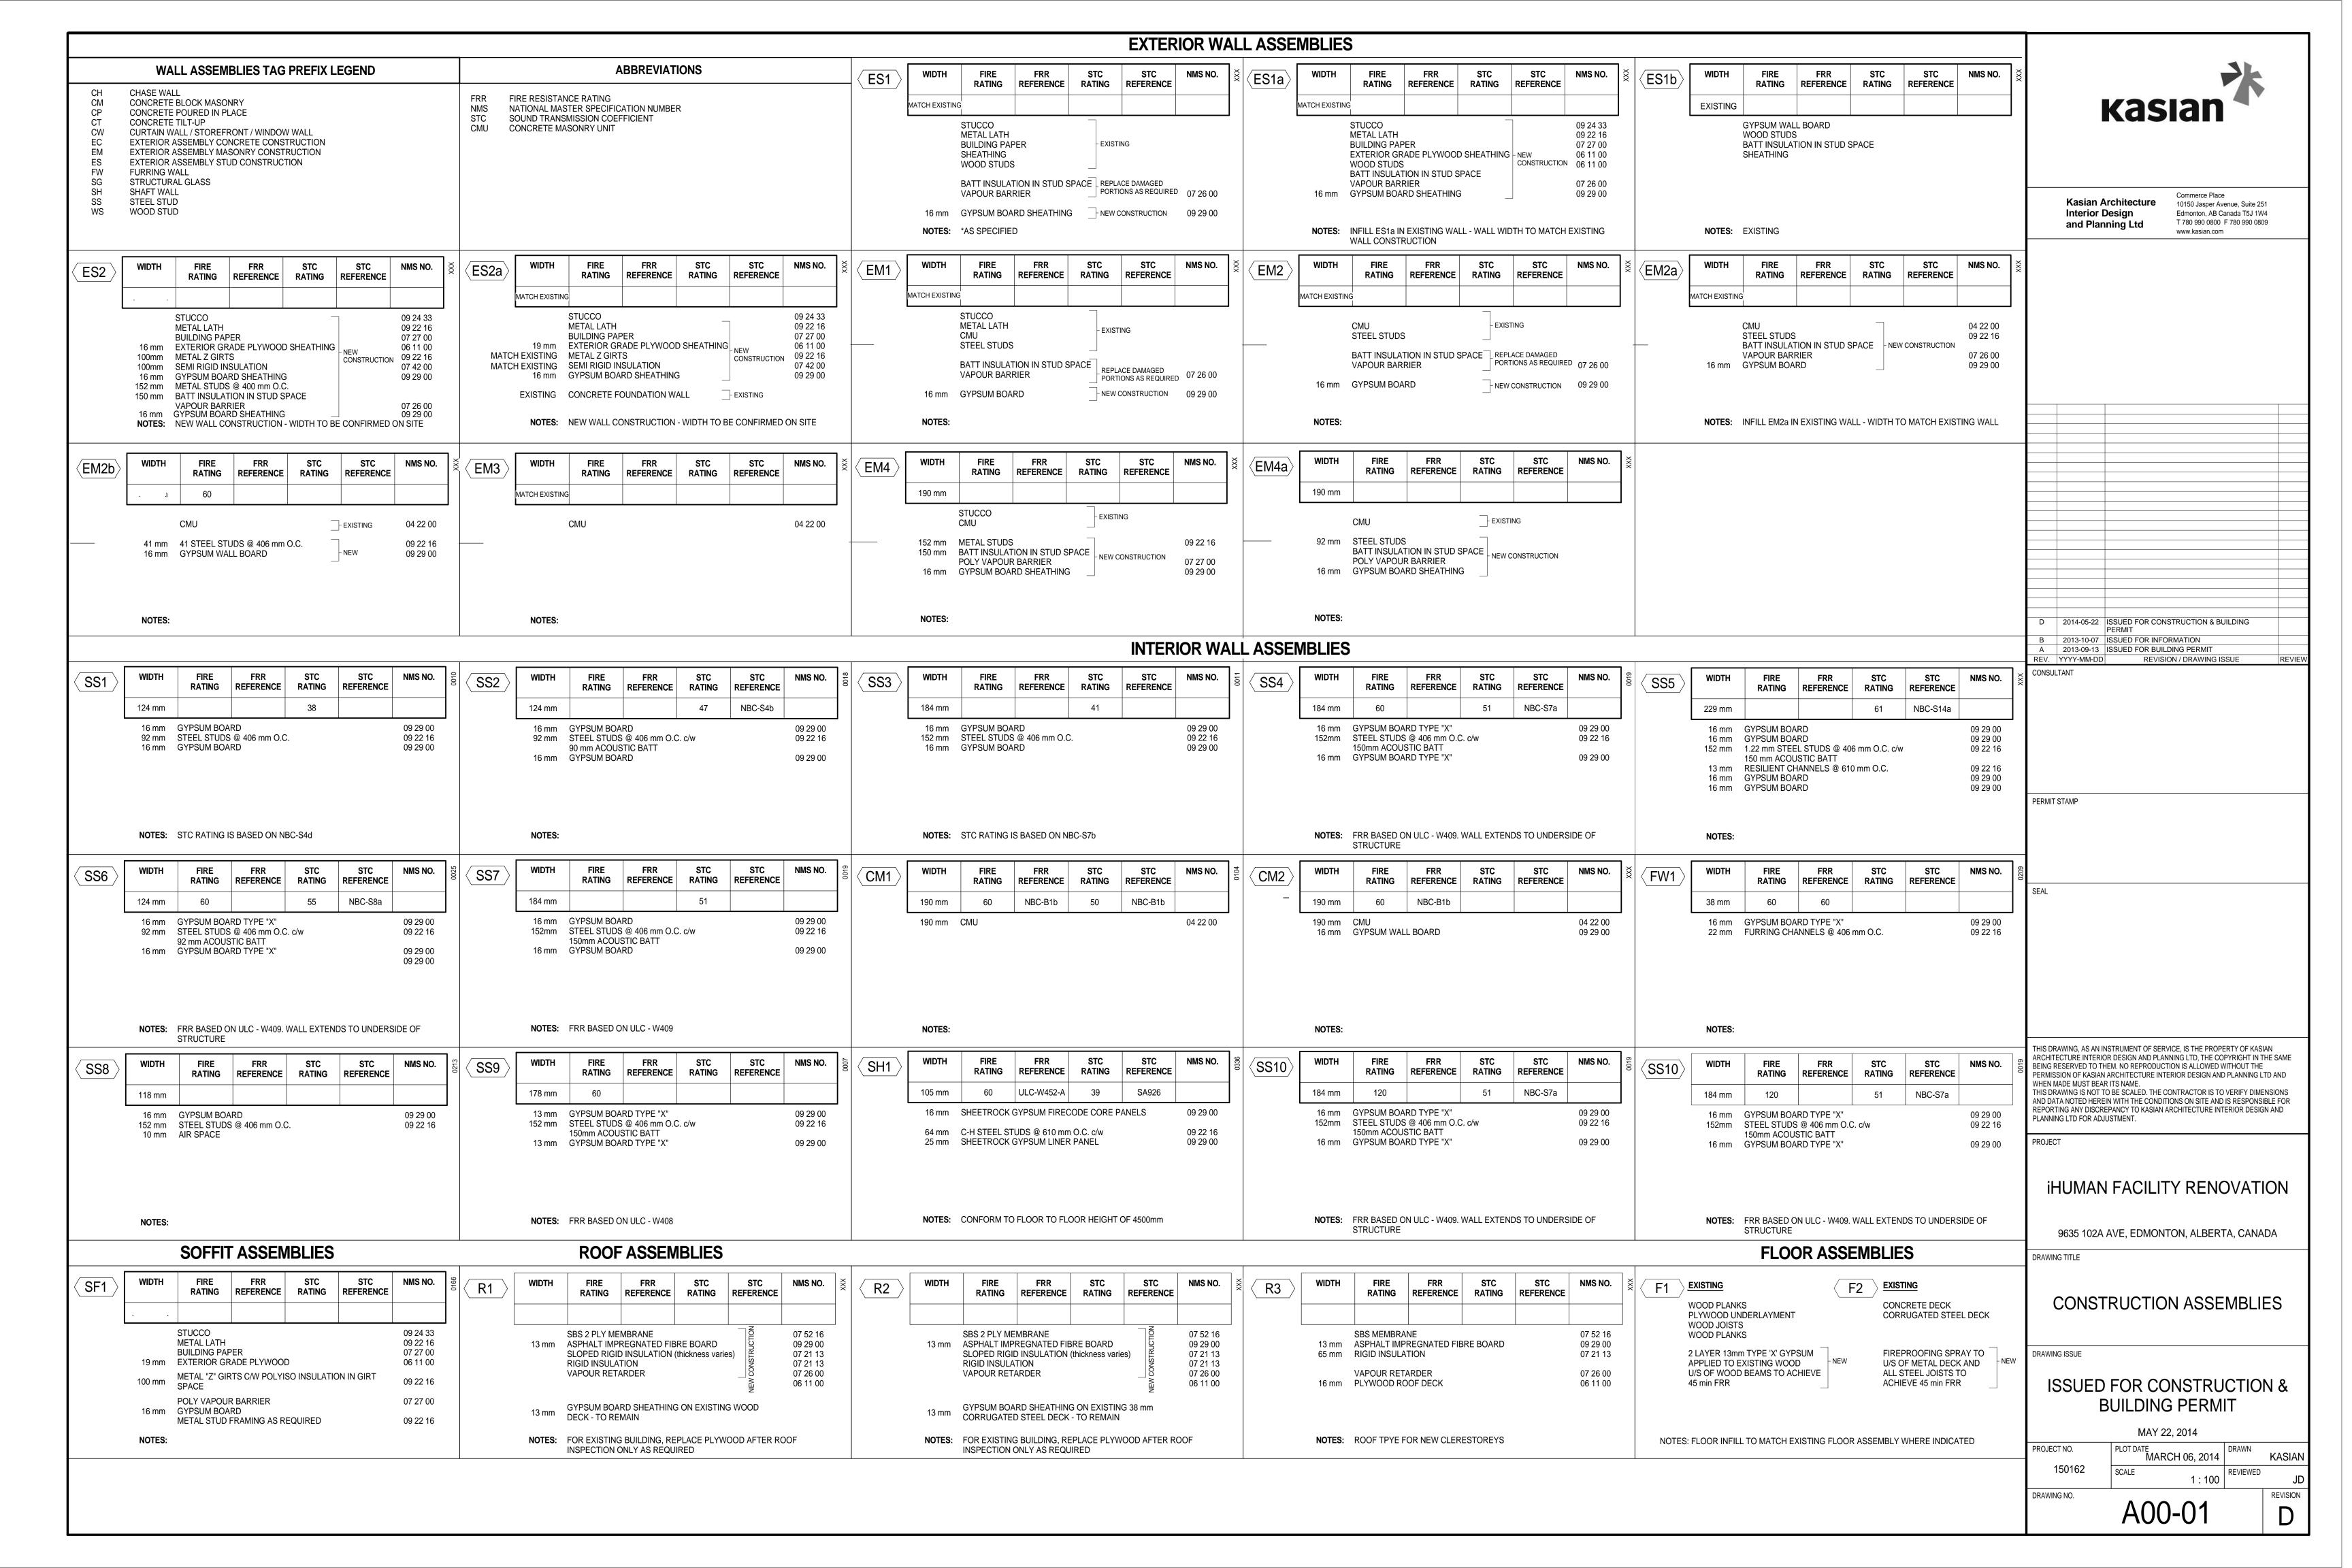


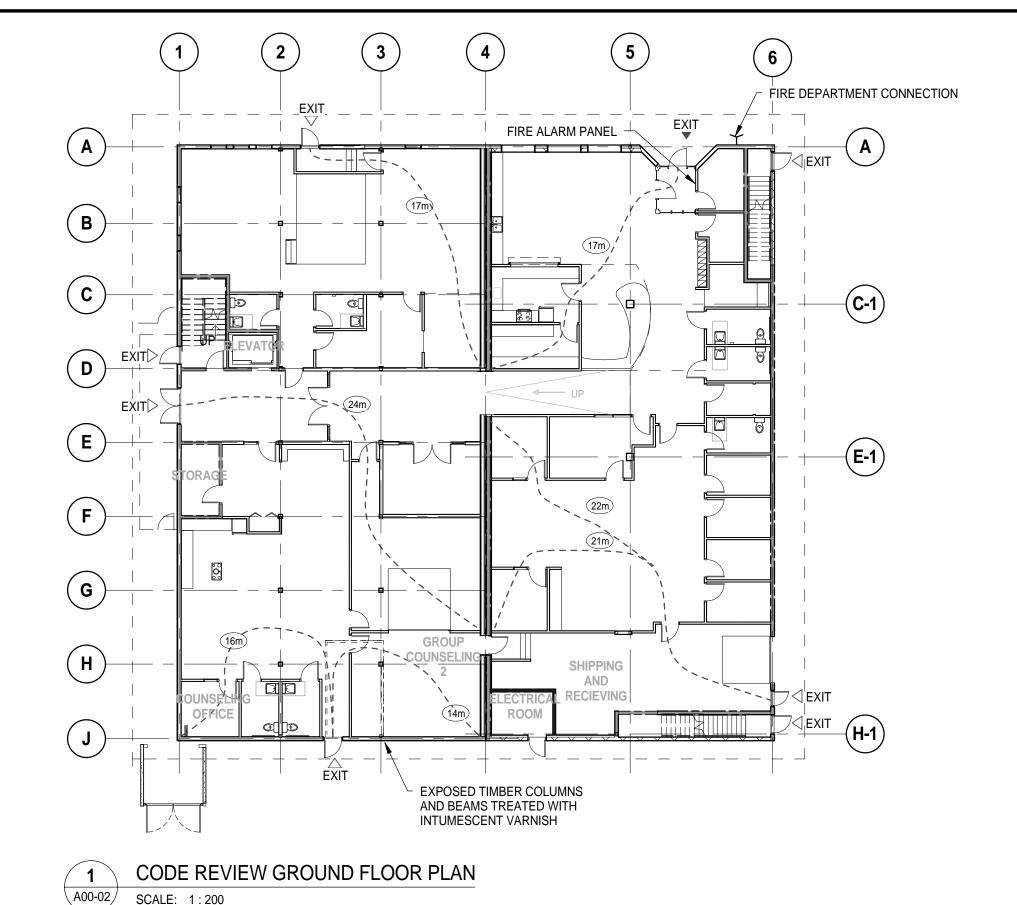


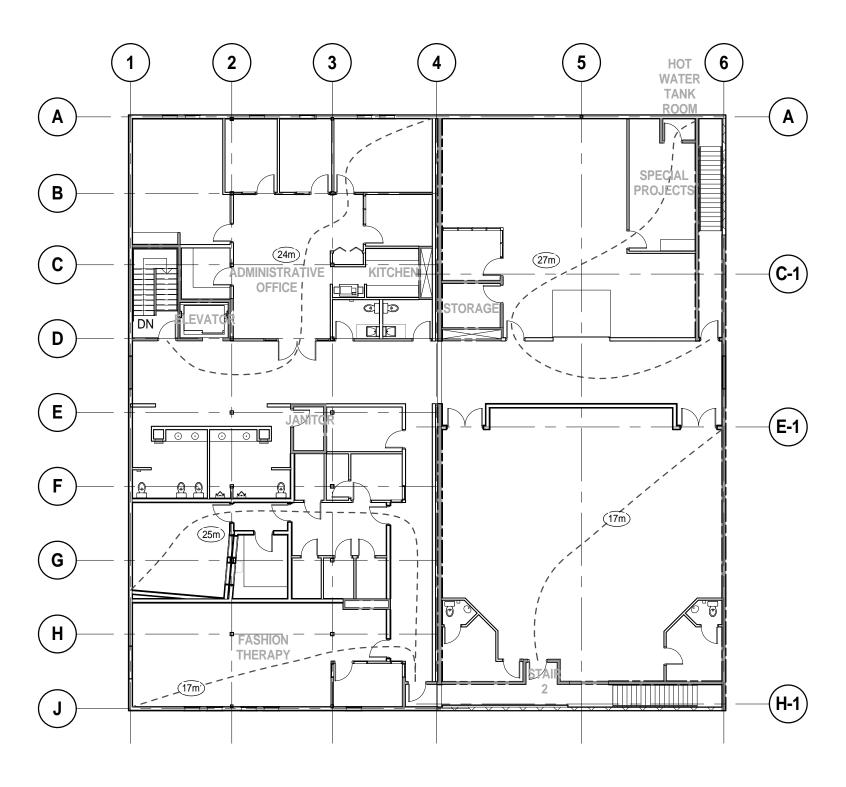


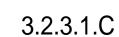


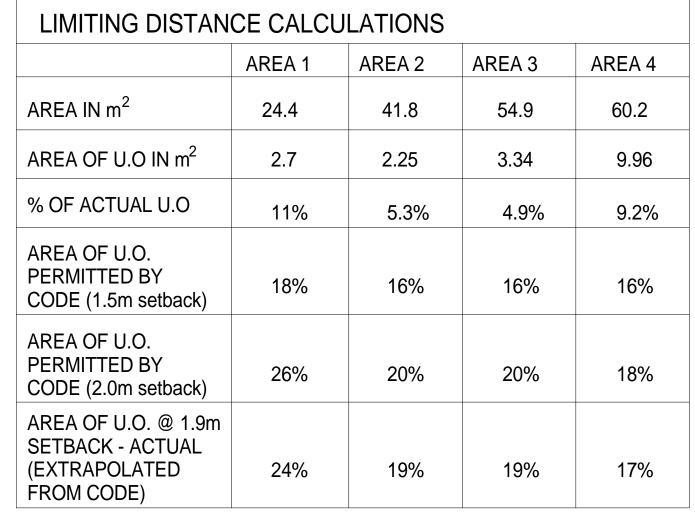


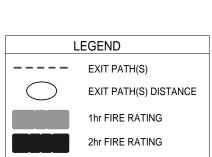












CODE ANALYSIS

Alberta Building Code 2006

This complex is being considered as one building for the purposes of Building Code evaluation.

Project Description

Change of use; interior alterations

Gross Building Areas: Existing 1996 m2 New1900 m2

Building Area Existing 998 m2 New960 m2

Construction: Two storeys, combustible and non-combustible construction, sprinklered

Heavy Timber

Construction 3.1.4.6 (2) Table 3.1.4.5; Columns supporting combustible 45 minute floors; minimum dimension 191 x 191. Existing timber beams are built up beams, 5 ply 75 x 305, fir. Code allows 130 x 228 or 175 x 190.

Intumescent Varnish required to supporting timber columns and beams.

Major Occupancies: Group A2 (Café/Classroom Space/Counseling areas)

Major Occupancy

Separation: Not required; per definition of *Major Occupancy*; subsidiary occupancies (office space etc) are an integral part of the principal occupancy

Classification: 3.2.2.26

Group A, Division 2 up to 3 storeys, increased Area, Sprinklered.

Construction 3.2.2.26 (2) Combustible and/or non-combustible construction permitted.

Maximum

Allowable Area: 3.2.2.26(c)(ii)Two Storey building in this classification has a maximum area of 2,400 m2

Floor Assemblies: 3.2.2.26 (2) (a) floor assemblies shall be fire separations and if of combustible construction shall have a 45 minute rating. Non-combustible floors are fire separations with no rating.

Appendix D Table D-2.3.12; Two layers 13mm Type X Fire Rated Drywall required to underside wood framed floor.

Load Bearing

Assemblies: 3.2.2.26 (2)(c) supporting combustible construction; 45 minute rating required. Supporting unrated non-combustible fire separations; no rating required. See 3.1.4.6; Heavy Timber Construction

Clear Intumescent Coating required to main floor wood columns and beams

A00-02

30 Unoccupied Space 20%

328

SCALE: 1:200

Roof Assembly: No fire rating required

Fire Stopping: 3.1.11 seal openings in fire rated wall and floor assemblies

Flame Spread Ratings: 3.1.13.2(1)

Occupant Load: Table 3.1.17.1

Exits: 25

OCCUPANT LOAD ACCORDING TO ABC 2006

Total Building Floor Area 1900m2 Classroom Style Space @ 20% area 380m2 1.85 m2 per person = occupant load of 206 Shops and Vocational space 45% area 855m2 9.30 m2 per person = occupant load of 92 Office Space 15% 285m2

9.30 m² per person = occupant load of

TOTAL OCCUPANT LOAD BY CODE

Sprinkler System: Required, 3.2.2.26

Travel Distance: 45 m, 3.4.2.5(1)(c) Exits at office area:

Distance between Exits: Exit stairs to be half the diagonal distance of the floor

Width and Height of Exits: Width 3.4.3.2

Corridors: 1100 mm Stairs: 1100 mm 800 mm Doors:

Height 3.4.3.4 Stairs: 2100mm

2030mm (1980 to u/s closer)

Exit Fire Separation: 3.4.4.1 (1) 45 minute fire separation

Panic Hardware

required: Exit doors & stair doors 3.4.6.12

Fire Alarm: Required, 3.2.4.1(1)

Standpipe Systems: Required, 3.2.5.8(1)

Fire Department

CODE REVIEW SECOND FLOOR PLAN

Connection: 3.2.5.16(1) located within 3 to 15 m of principle entrance and not more than 45 m unobstructed to a fire hydrant

Fire Extinguishers: 3.2.5.17(1) Required in accordance with Alberta Fire Code

Elevator Required, 3.8.2.1 See section 3.2.6.4 for emergency operation and

3.2.6.5 for Fire Fighters requirements.

Elevator Hoistway, Doors & Machine Room: 3.5.3.1(1);45 minute fire rating,

Janitor Room: 3.3.1.21(3); Fire separation without fire rating

Service Rooms

with fuel-fired Appliances: 3.6.2.1(8); rating not required to a room with gas fired hot water tank

Electrical Room: 3.6.2.1 (6) 1 hour fire rating

(main floor water meter room/sprinkler room)

Barrier Free Design: 3.8.2.1; Building must be fully barrier free

BUILDING SECTION - FIRE SEPERATION AT

FLOORS

A-1 Cafe SCALE: 1:100

4

Barrier Free

Parking Stalls: 3.8.2.2; one barrier free stall required.

WOOD BUILDING: 1hr FIRE RESISTANT RATING ACHIEVED WITH STEEL BUILDING: 45 MINUTE FIRE RESISTANCE RATING 2x 16mm 'TYPE X' GYPSUM BOARD APPLIED TO UNDERSIDE OF EXISTING FLOOR **ACHIEVED WITH** SPRAYED FIRE-PROOFING APPLIED TO UNDERSIDE OF FLOOR, & STEEL JOISTS 6 (4 ROOF 1 8280 ROOF 2 7112 SECOND 3810 MAIN 2 533 ◆ MAIN 1 ALL LOAD BEARING COLUMNS ON

MAIN FLOOR TO BE 45 MINUTE

Water Closets

Washroom

& Lavatories 7.2.2

Requirements: Main Floor Café;

7.2.2.5(1) two universal toilet rooms provided required for 25 females and 35 males (total 60 persons)

Total Occupant load 328 persons

Table 7.2.2.6.B for Assembly Occupancies (presumed 50/50 split male to female)

6 water closets or Male use 8 water closets for Female Use

Washrooms provided:

Main Floor: 7 water closers in washrooms planned as universal washrooms to be signed male/female per owners requirements

Second Floor: 4 water closets in assigned female washrooms, 4 water closets/urinals in assigned male washrooms. 2 convenience washrooms in dressing

FIRE RATED

TOTAL WATER CLOSET COUNT = 19 TOTAL WATER CLOSETS REQUIRED PER ABC = 14 2014-05-22 ISSUED FOR CONSTRUCTION & BUILDING PERMIT

REVISION / DRAWING ISSUE

2013-10-07 ISSUED FOR INFORMATION 2013-09-13 ISSUED FOR BUILDING PERMIT

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PROJECT

iHUMAN FACILITY RENOVATION

9635 102A AVE, EDMONTON, ALBERTA, CANADA

DRAWING TITLE

CODE REVIEW PLANS & ANALYSIS

ISSUED FOR CONSTRUCTION & BUILDING PERMIT

MAY 22, 2014

PLOT DATE MARCH 06, 2014 REVIEWED As indicated REVISION DRAWING NO.

A00-02

									D	OOR & I	FRAME SCH	EDULE						
			DOO	R PARA	METERS				DOOR		FRAME	FRAME	FRAME	FRAME	FRAME PARAM ETERS			
DOOR NO.	FROM	ТО	TYPE	WIDTH	HEIGHT	NS THK	Door Material	7.	FINISH	FRAME TYPE	OVERALL WIDTH	OVERALL HEIGHT	MATL	INSUL	FINISH	OPENING FRR	HARDWARE GROUP	COMMENTS
D100A D100B	100 124	OUTSIDE 100	GA1 GA1	950 950	2325 2325		ALUM ALUM	TSG TSG	ALUM ALUM	-			ALUM ALUM		ALUM ALUM			
D101 D102	100 102	101 OUTSIDE	SD1 SD1	915 914	2135 2135	45 45	HM HM		PTD PTD	F1 F1			PS PS		PTD PTD			EXISTING TO REMAIN
D103 D105	124 105	103 124	SD1 SD1	915 915	2135 2135	45 45	WD WD		PTD PTD	F1 F1	964	2185	WD WD	No	PTD PTD			
D106	124 120	106 107	SD1	915	2135	45	WD WD		PTD PTD	F1 F1	964	2185	WD WD	No	PTD PTD			
D107 D108	117	108	SD1	915 915	2135 2135	45 45	WD		PTD	F1			WD	No	PTD			
D109 D110	117 110	109 117	SD6 SD6	915 915	2135 2135	45 45	WD WD	TSG TSG	PTD PTD	F1 F1			WD WD		PTD PTD			
D110 D111	120 117	117 111	SD6 SD6	915 915	2135 2135	45 45	WD WD	TSG TSG	PTD PTD	F1 F1			WD WD		PTD PTD			
D112 D113A	112 117	117 113	SD6 SD4	915 915	2135 2135	45 45	WD HM	TSG TSG	PTD PTD	F1 F1			WD PS		PTD PTD			
D113B	113	OUTSIDE	OH4	2450	2475	51	НМ	130	PTD	-			PS		PTD			EXISTING TO REMAIN
D113C D113D	113 137	OUTSIDE 113	SD1 SD4	762 915	2134 2135	45 45	HM HM	TSG	PTD PTD	F1	1015	2185	PS PS	No	PTD PTD			EXISTING TO REMAIN
D114 D115	114 OUTSIDE	OUTSIDE 115	SD1 SD1	914 864	2135 2135	45 45	HM HM		PTD PTD	F1 F1	1015	2185	PS PS	No Yes	PTD PTD			EXISTING TO REMAIN THERMALLY BROKEN
D116 D118	117 117	116 118	SD6 SD6	915 915	2135 2135	45 45	WD WD	TSG TSG	PTD PTD	F1 F1			WD WD		PTD PTD			
D119A	119	117	SD6	915	2135	45	WD		PTD	F1			WD		PTD			
D119B D122A	120 121	119 122	SD6 SD6	915 915	2135 2135	45 45	WD WD	TSG TSG	PTD PTD	F1 F1			WD		PTD PTD			
D122B D123	124 122	122 123	CD1 SD4	2500 915	2500 2135	45	ALUM WD	TSG	ALUM PTD	- F1			PS WD		PTD PTD			ROLLING COUNTER SHUTTER
D125A D125B	125 126	OUTSIDE 125	SD6 SD5	915 915	2135 2135	45 45	HM WD	TSG	PTD PTD	F1 F1	964 964	2185 2185	PS WD	Yes	PTD PTD			THERMALLY BROKEN
D126	126	133	SD1	915	2135	45	WD	.55	PTD	F1			WD	V	PTD	45		THEDMALLY PROVEN
D127 D128A	132 126	OUTSIDE 128	SD4 SD4	915 915	2135 2135	45 45	HM WD	TSG	PTD PTD	F1 F1	1015	2185	PS WD	Yes	PTD PTD	45		THERMALLY BROKEN
D128B D129	126 129	128 126	SD4 SD1	915 864	2135 2135	45 45	WD WD	TSG	PTD PTD	F1 F1			WD WD		PTD PTD			
D130 D132	126 133	130 132	SD1 SD4	864 915	2135 2135	45 45	WD HM	TSG	PTD PTD	F1 F1			WD WD		PTD PTD			
D133	133	OUTSIDE	DD6	1830	2135	45	НМ		PTD	F2			PS	Yes	PTD			
D134 D135	134 134	133 135	DD6 DD6	2000	2160 2160	45 45	WD WD	TSG TSG	PTD PTD	F12 F12			WD WD		PTD PTD			
D136A D136B	136 141	134 136	SD4 SD4	915 915	2135 2135	45 45	WD WD	TSG TSG	PTD PTD	F1 F1			WD WD		PTD PTD			
D136C D137	136 141	137 137	OH1 SD4	3250	3200	51	HM WD	TSG	PTD PTD	-	1015	2185	PS WD	No	PTD PTD			
D138	141	138	SD1	915 915	2135 2135	45 45	WD	156	PTD	F1 F1	964	2185	WD	No No	PTD			
D139 D140	139 141	141 140	SD1 SD7	915 915	2135 2135	45 45	WD WD	TSG	PTD PTD	F1 F1	1015	2185	WD WD	No	PTD PTD			
D141A D141B	133 141	141 OUTSIDE	SD4 SD1	915 915	2135 2135	45 45	WD HM	TSG	PTD PTD	F1 F1	1015	2185	WD PS	Yes	PTD PTD			THERMALLY BROKEN
D141C	CLOSET 141	141	BF2 SD4	1524 915	2032	38	WD HM		PTD PTD	BF2 F1			WD PS		PTD PTD			
D200A	206	200	SD6	915	2135	45	WD	TSG	PTD	F1	1930	2185	WD		PTD			
D200B D201	200	206 201	OH1 SD6	3000 915	2439 2135	51 45	HM WD	TSG	PTD PTD	- F1			PS WD		PTD PTD			
D202 D203	201 203	202 206	SD6 SD4	915 915	2135 2135	45 45	HM HM	TSG	PTD PTD	F1 F1			PS PS		PTD PTD	45		
D204	200	204	SD4	915	2135	45	НМ	TSG	PTD	F1	1015	2185	PS	No	PTD	45		
D205 D207A	200	205 206	SD6 DD6	915 1830	2135 2135	45 45	WD SCW	TSG TSG	PTD PTD	F1 F2	1015	2185	WD		PTD PTD			
D207B D208	207 209	206 208	DD6 SD1	1830 864	2135 2135	45 45	SCW WD		PTD PTD	F2 F1	<u> </u>		WD WD		PTD PTD			
D209 D209	207 133	209 131	SD1 ELEV	864 1067	2135 2135	45 45	WD HM		PTD PTD	F1			WD PS		PTD PTD			
D210A	207	210	SD4	915	2135	45	НМ	TSG	PTD	F1			PS		PTD PTD	AE		
D210B D211	211	210	SD4 SD1	915 864	2135 2135	45 45	HM WD		PTD PTD	F1 F1			PS WD		PTD	45		
D212 D213	212 221	211 213	SD1 SD6	864 915	2135 2135	45 45	WD WD	TSG	PTD PTD	F1 F1			WD PS		PTD PTD			
D214 D215	214 221	221 215	SD6 SD6	915 915	2135 2135	45 45	WD WD	TSG TSG	PTD PTD	F1 F1	1015 1015	2185 2185	WD WD		PTD PTD			
D216	221	216	SD6	915	2135	45	WD	TSG	PTD	F1	1015	2185	WD	No	PTD			
D217 D219	217 219	221 225	SD6 SD1	915 915	2135 2135	45 45	WD WD	TSG TSG	PTD PTD	F1 F1	1015	2185	WD		PTD PTD			
D220 D221	225 CLOSET	220 221	SD1 BF2	915 1524	2135 2032	45 38	WD WD	TSG	PTD PTD	F1 BF2			WD PS		PTD PTD			
D222 D223	222 221	225 223	ELEV SD4	1067 915	2135 2135	45 45	HM HM	TSG	PTD PTD	- F1			PS PS		PTD PTD			
D224	225	224	SD4	915	2135	45	НМ	TSG	PTD	F1			PS		PTD	45		
D225 D226	221 225	225 226	DD6 SD6	2000 915	2160 2135	45 45	WD WD	TSG	PTD PTD	F12 F1			WD WD		PTD PTD			
D227 D228	230 227	227 228	SD6 SD1	915 864	2135 2135	45 45	WD WD		PTD PTD	F1 F1			WD WD		PTD PTD			
D229 D230	229	230	SD1 SD6	864 915	2135 2135	45 45	SCW SCW		PTD PTD	F1 F1			WD WD	Yes	PTD PTD			Acoustic door
D231	231	230	SD1	864	2135	45	SCW		PTD	F1			WD	Yes	PTD			Acoustic door
D232 D233	232 233	230 230	SD1 SD1	864 864	2135 2135	45 45	SCW SCW		PTD PTD	F1 F1	<u> </u>		WD WD	Yes Yes	PTD PTD			Acoustic door Acoustic door
D234 D235	235 225	234 235	SD6 SD6	915 915	2135 2135	45 45	WD WD	TSG	PTD PTD	F1 F1			WD WD		PTD PTD			
D236 D237	238	236	SD1	915	2135	45	SCW		PTD	F1			WD	Yes	PTD			Acoustic door
11/1/	238	237 238	SD1 SD1	915 864	2135 2135	45 45	SCW WD		PTD PTD	F1 F1	1		WD WD	Yes Yes	PTD PTD			Acoustic door Acoustic door

DOOR / FRAME LEGENDS & ABBREVIATIONS

LEGEND / ABBREVIATIONS DOOR TYPES LEGEND

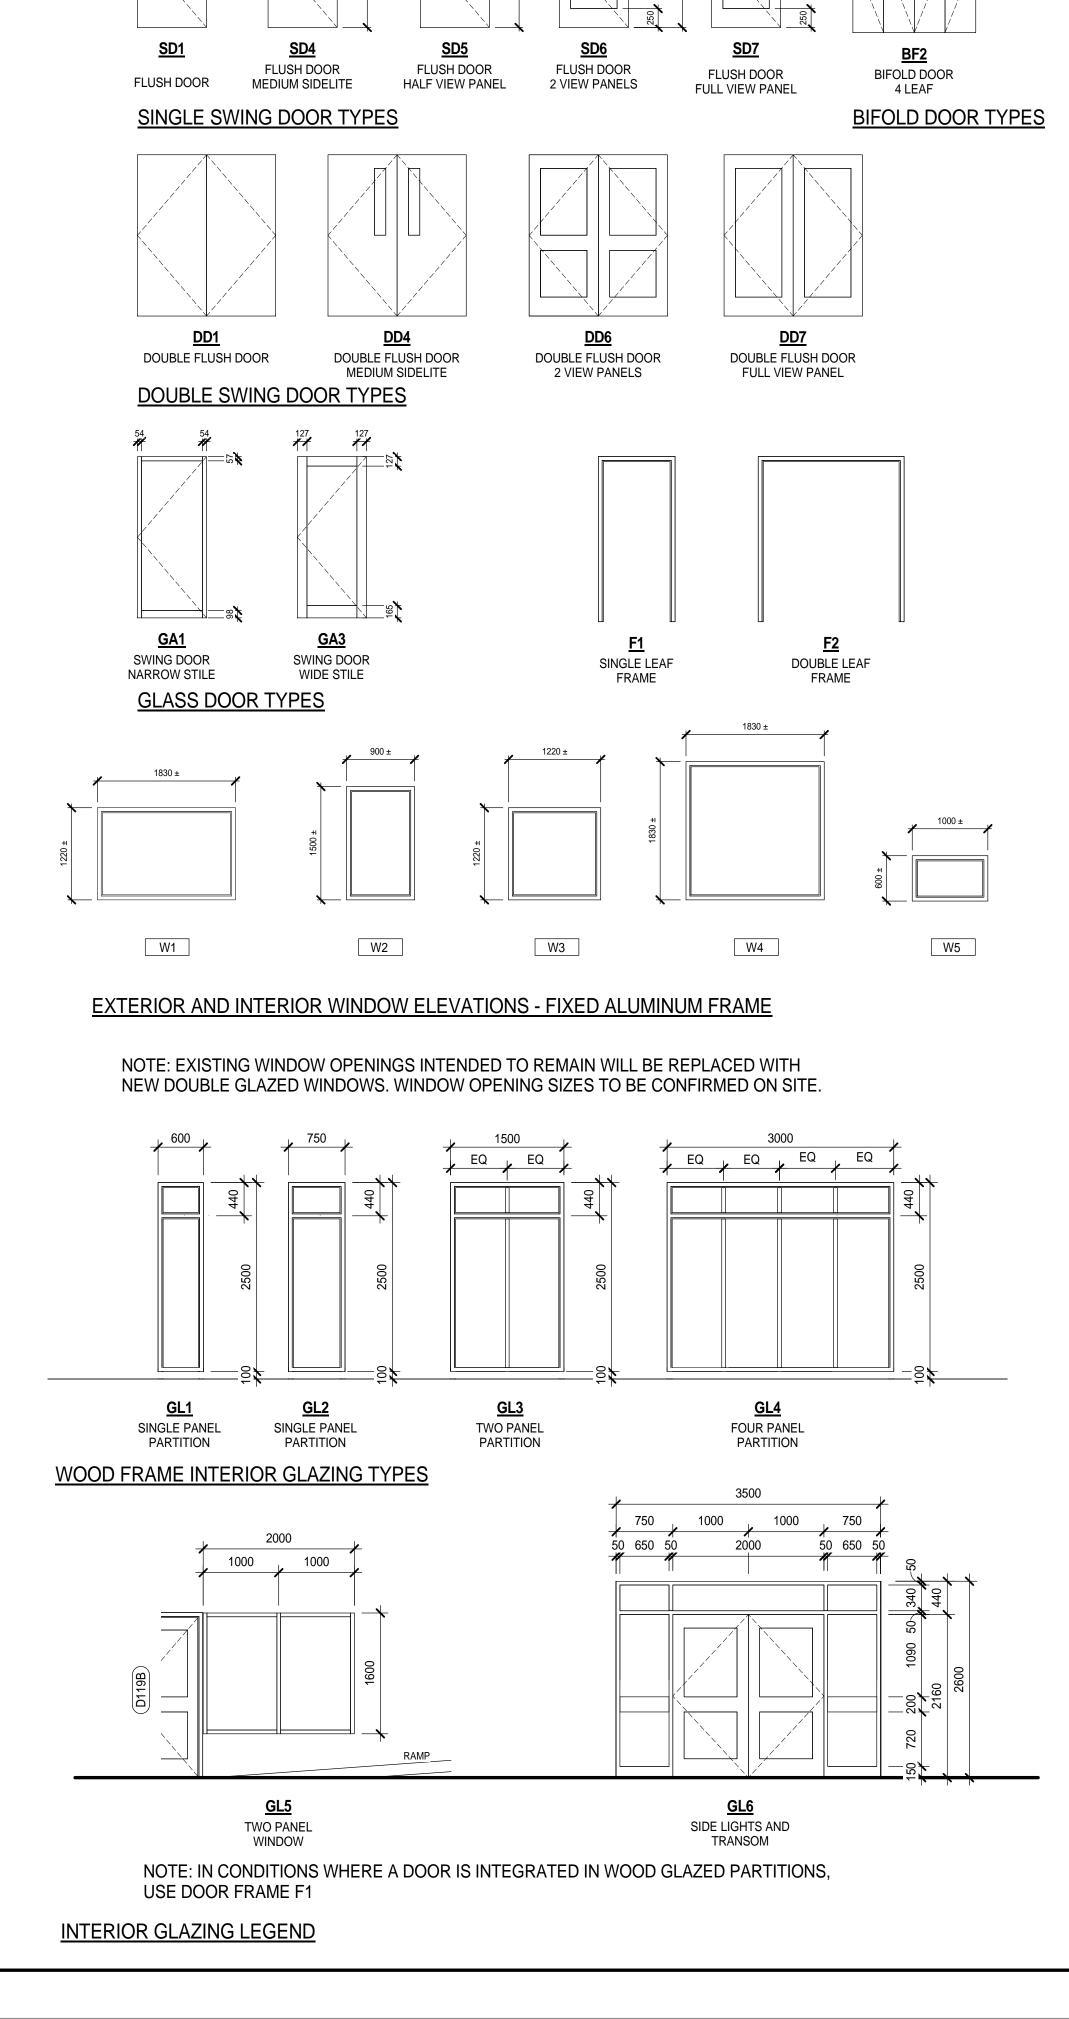
ALUM ALUMINUM
EXT EXTERIOR
F FRAME
G() GLASS (type)
GWG GEORGIAN WIRE GLASS
HM HOLLOW METAL
N/A NOT APPLICABLE
PS PRESSED STEEL

PTD SCW TSG PAINTED

SOLID CORE WOOD

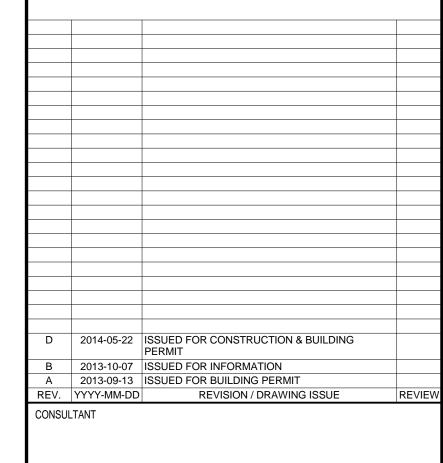
TEMPERED SAFETY GLASS

BF BIFOLD DOOR
CD COILING DOOR
DD DOUBLE SWING DOOR
SD SINGLE SWING DOOR
FRR FIRE RESISTANCE RATING





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PROJECT

HUMAN FACILITY RENOVATION

9635 102A AVE, EDMONTON, ALBERTA, CANADA

DRAWING TITLE

DOOR & FRAME SCHEDULE & GLAZING ELEVATIONS

DRAWING ISSUE

DRAWING NO.

ISSUED FOR CONSTRUCTION & BUILDING PERMIT

MAY 22, 2014

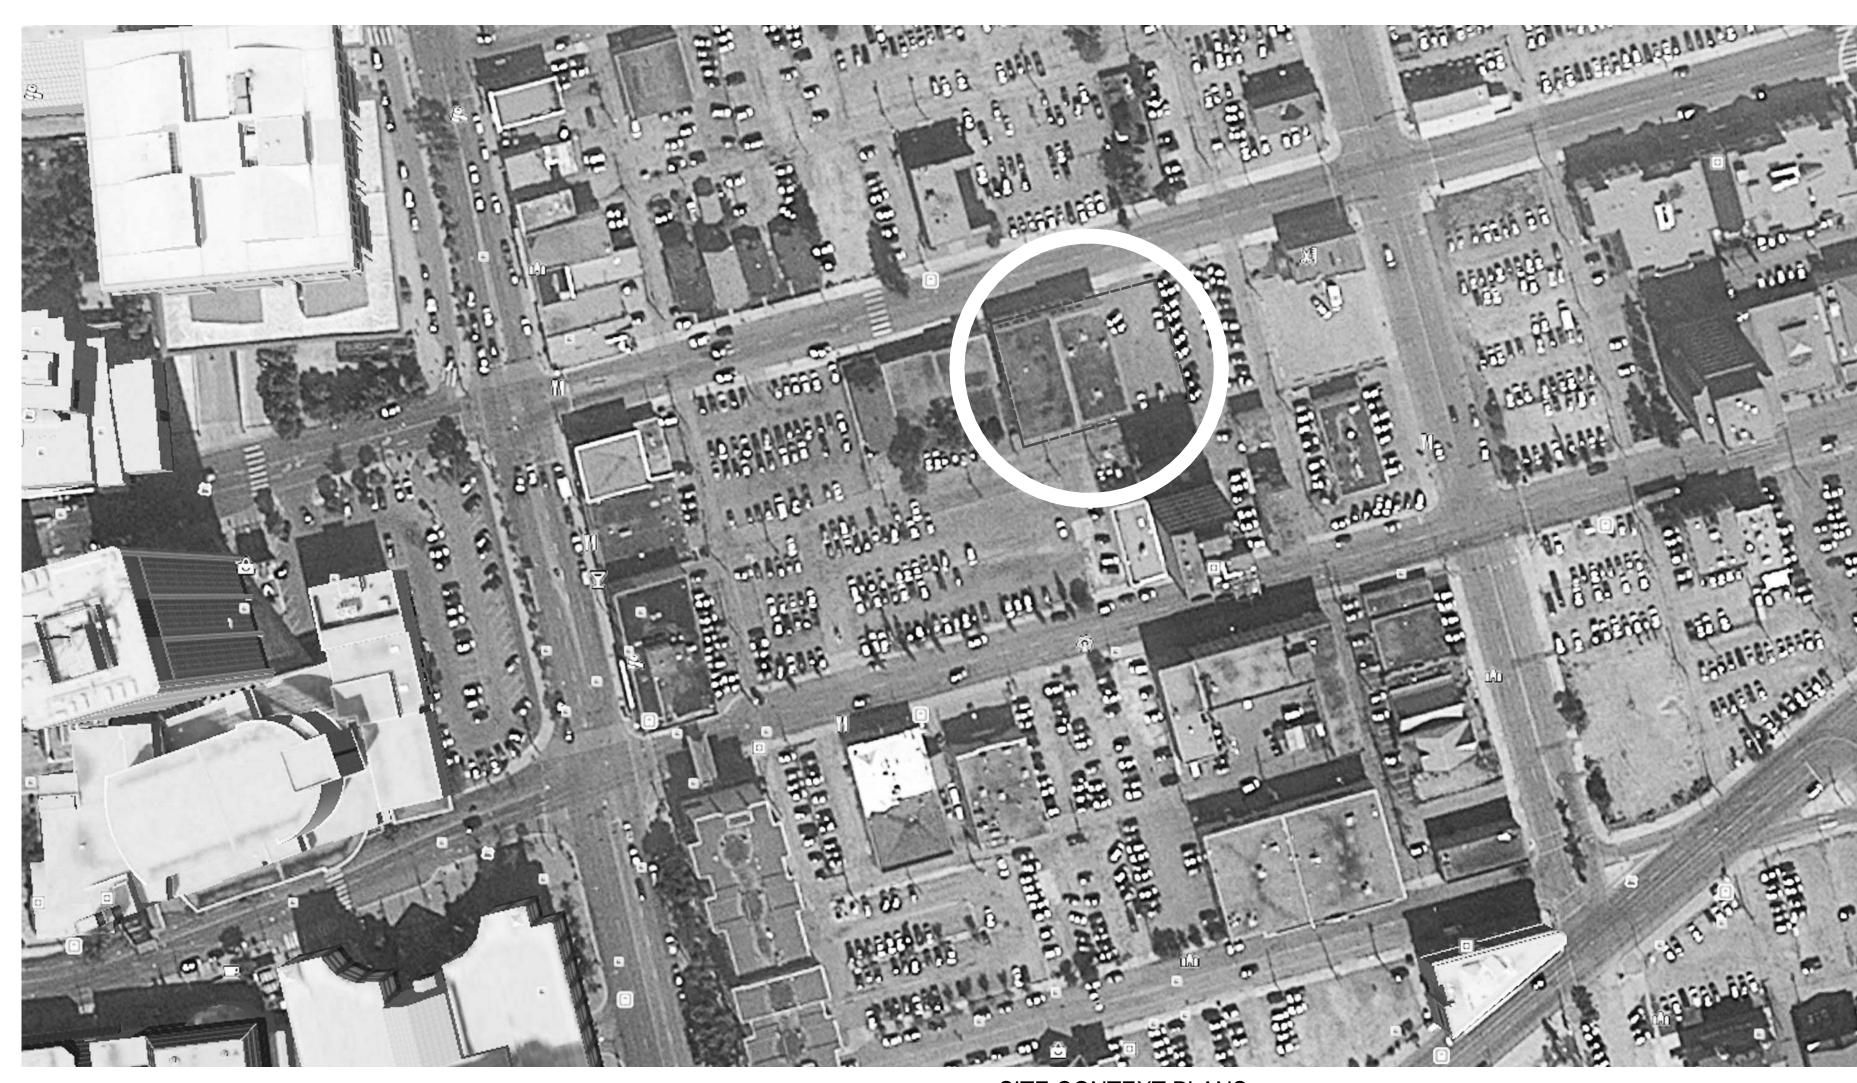
PLOT DATE MARCH 06, 2014 CRAWN

150162 SCALE As indicated REVIEWED JD

A00-03

REVISION





SITE CONTEXT PLANS

SITE STATISTICS

MUNICIPAL ADDRESS: 9635 - 102A AVENUE

SITE ZONING: DC1 - CIVIC QUARTERS

LEGAL DESCRIPTION: LOT 48 AFTER CONSOLIDATION (PREVIOUSLY 11, 12, 13, 14 & 15) BLOCK: 6 PLAN: ND

SITE AREA: 20,085 SF (1,867 SM) 0.46 ACRES (EXISTING)

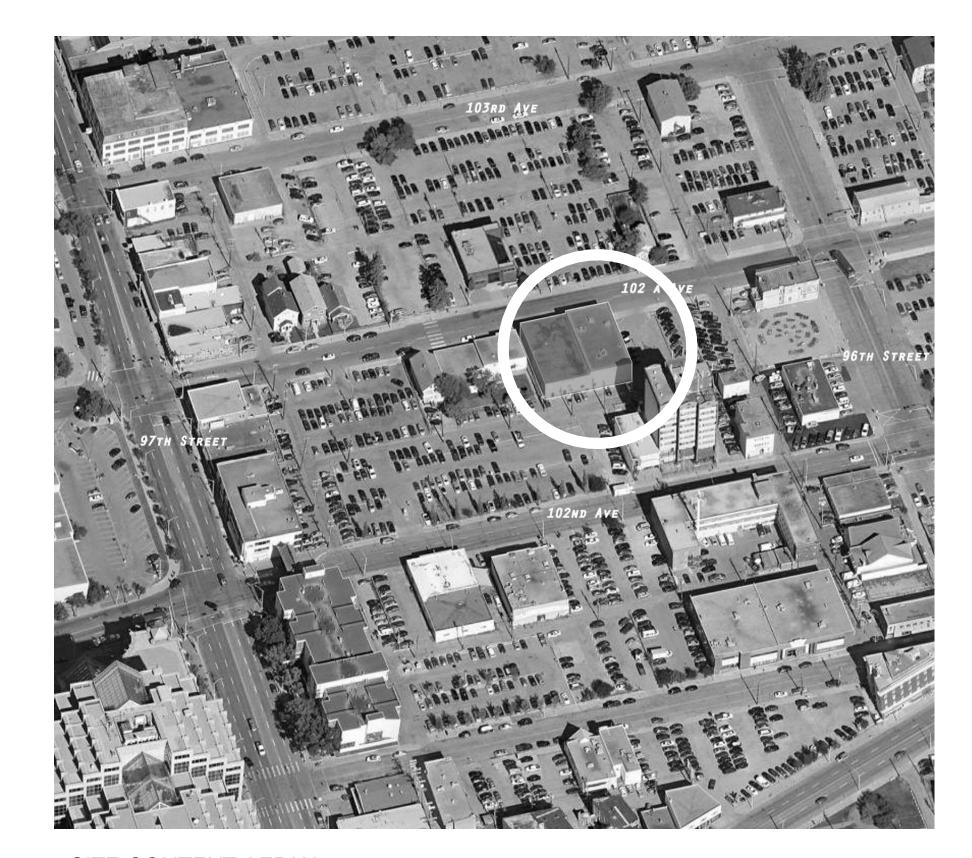
SITE COVERAGE: 53% (EXISTING)

OCCUPANCY GROUP: HEALTH SERVICES - B2

PROGRAM STATISTICS

GROUND FLOOR - 984 SM

2ND FLOOR - 988 SM



SITE CONTEXT AERIAL





Interior Design and Planning Ltd 10150 Jasper Avenue, Suite 251 Edmonton, AB Canada T5J 1W4 T 780 990 0800 F 780 990 0809

D	2014-05-22	ISSUED FOR CONSTRUCTION & BUILDING PERMIT	
В	2013-10-07	ISSUED FOR INFORMATION	
Α	2013-09-13	ISSUED FOR BUILDING PERMIT	
REV.	YYYY-MM-DD	REVISION / DRAWING ISSUE	RE

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iHUMAN FACILITY RENOVATION

9635 102A AVE, EDMONTON, ALBERTA, CANADA

DRAWING TITLE

SITE CONTEXT

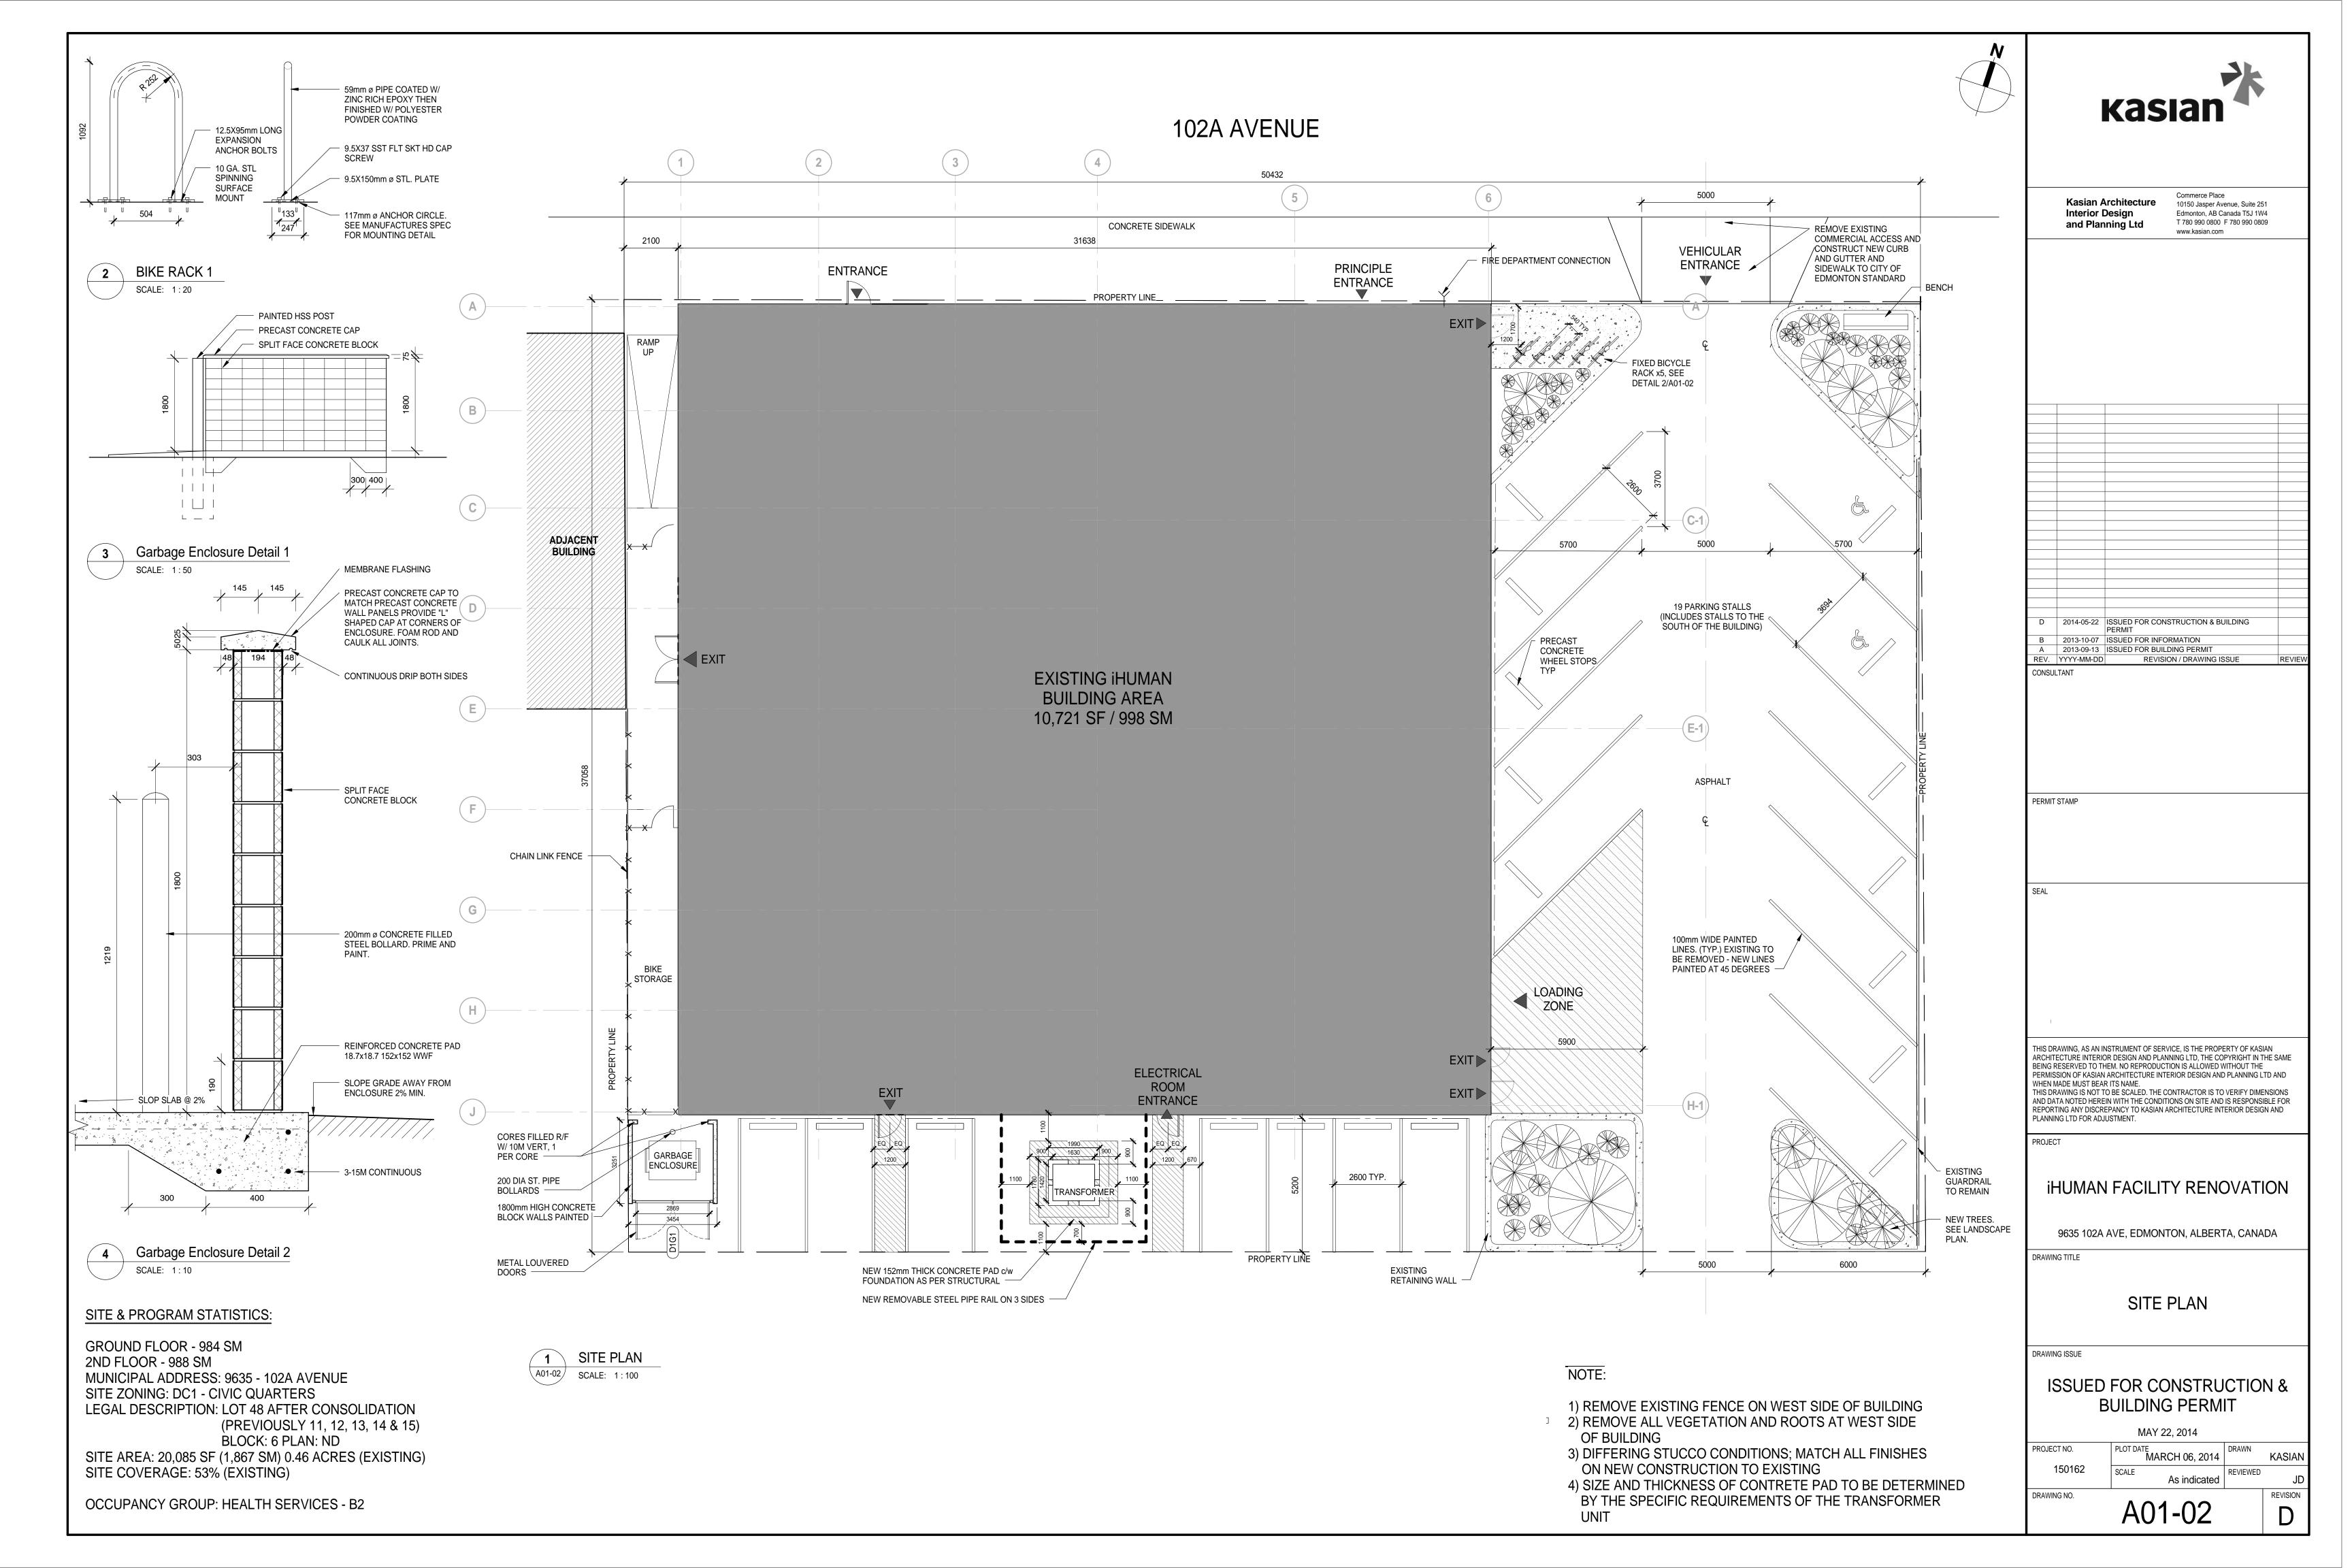
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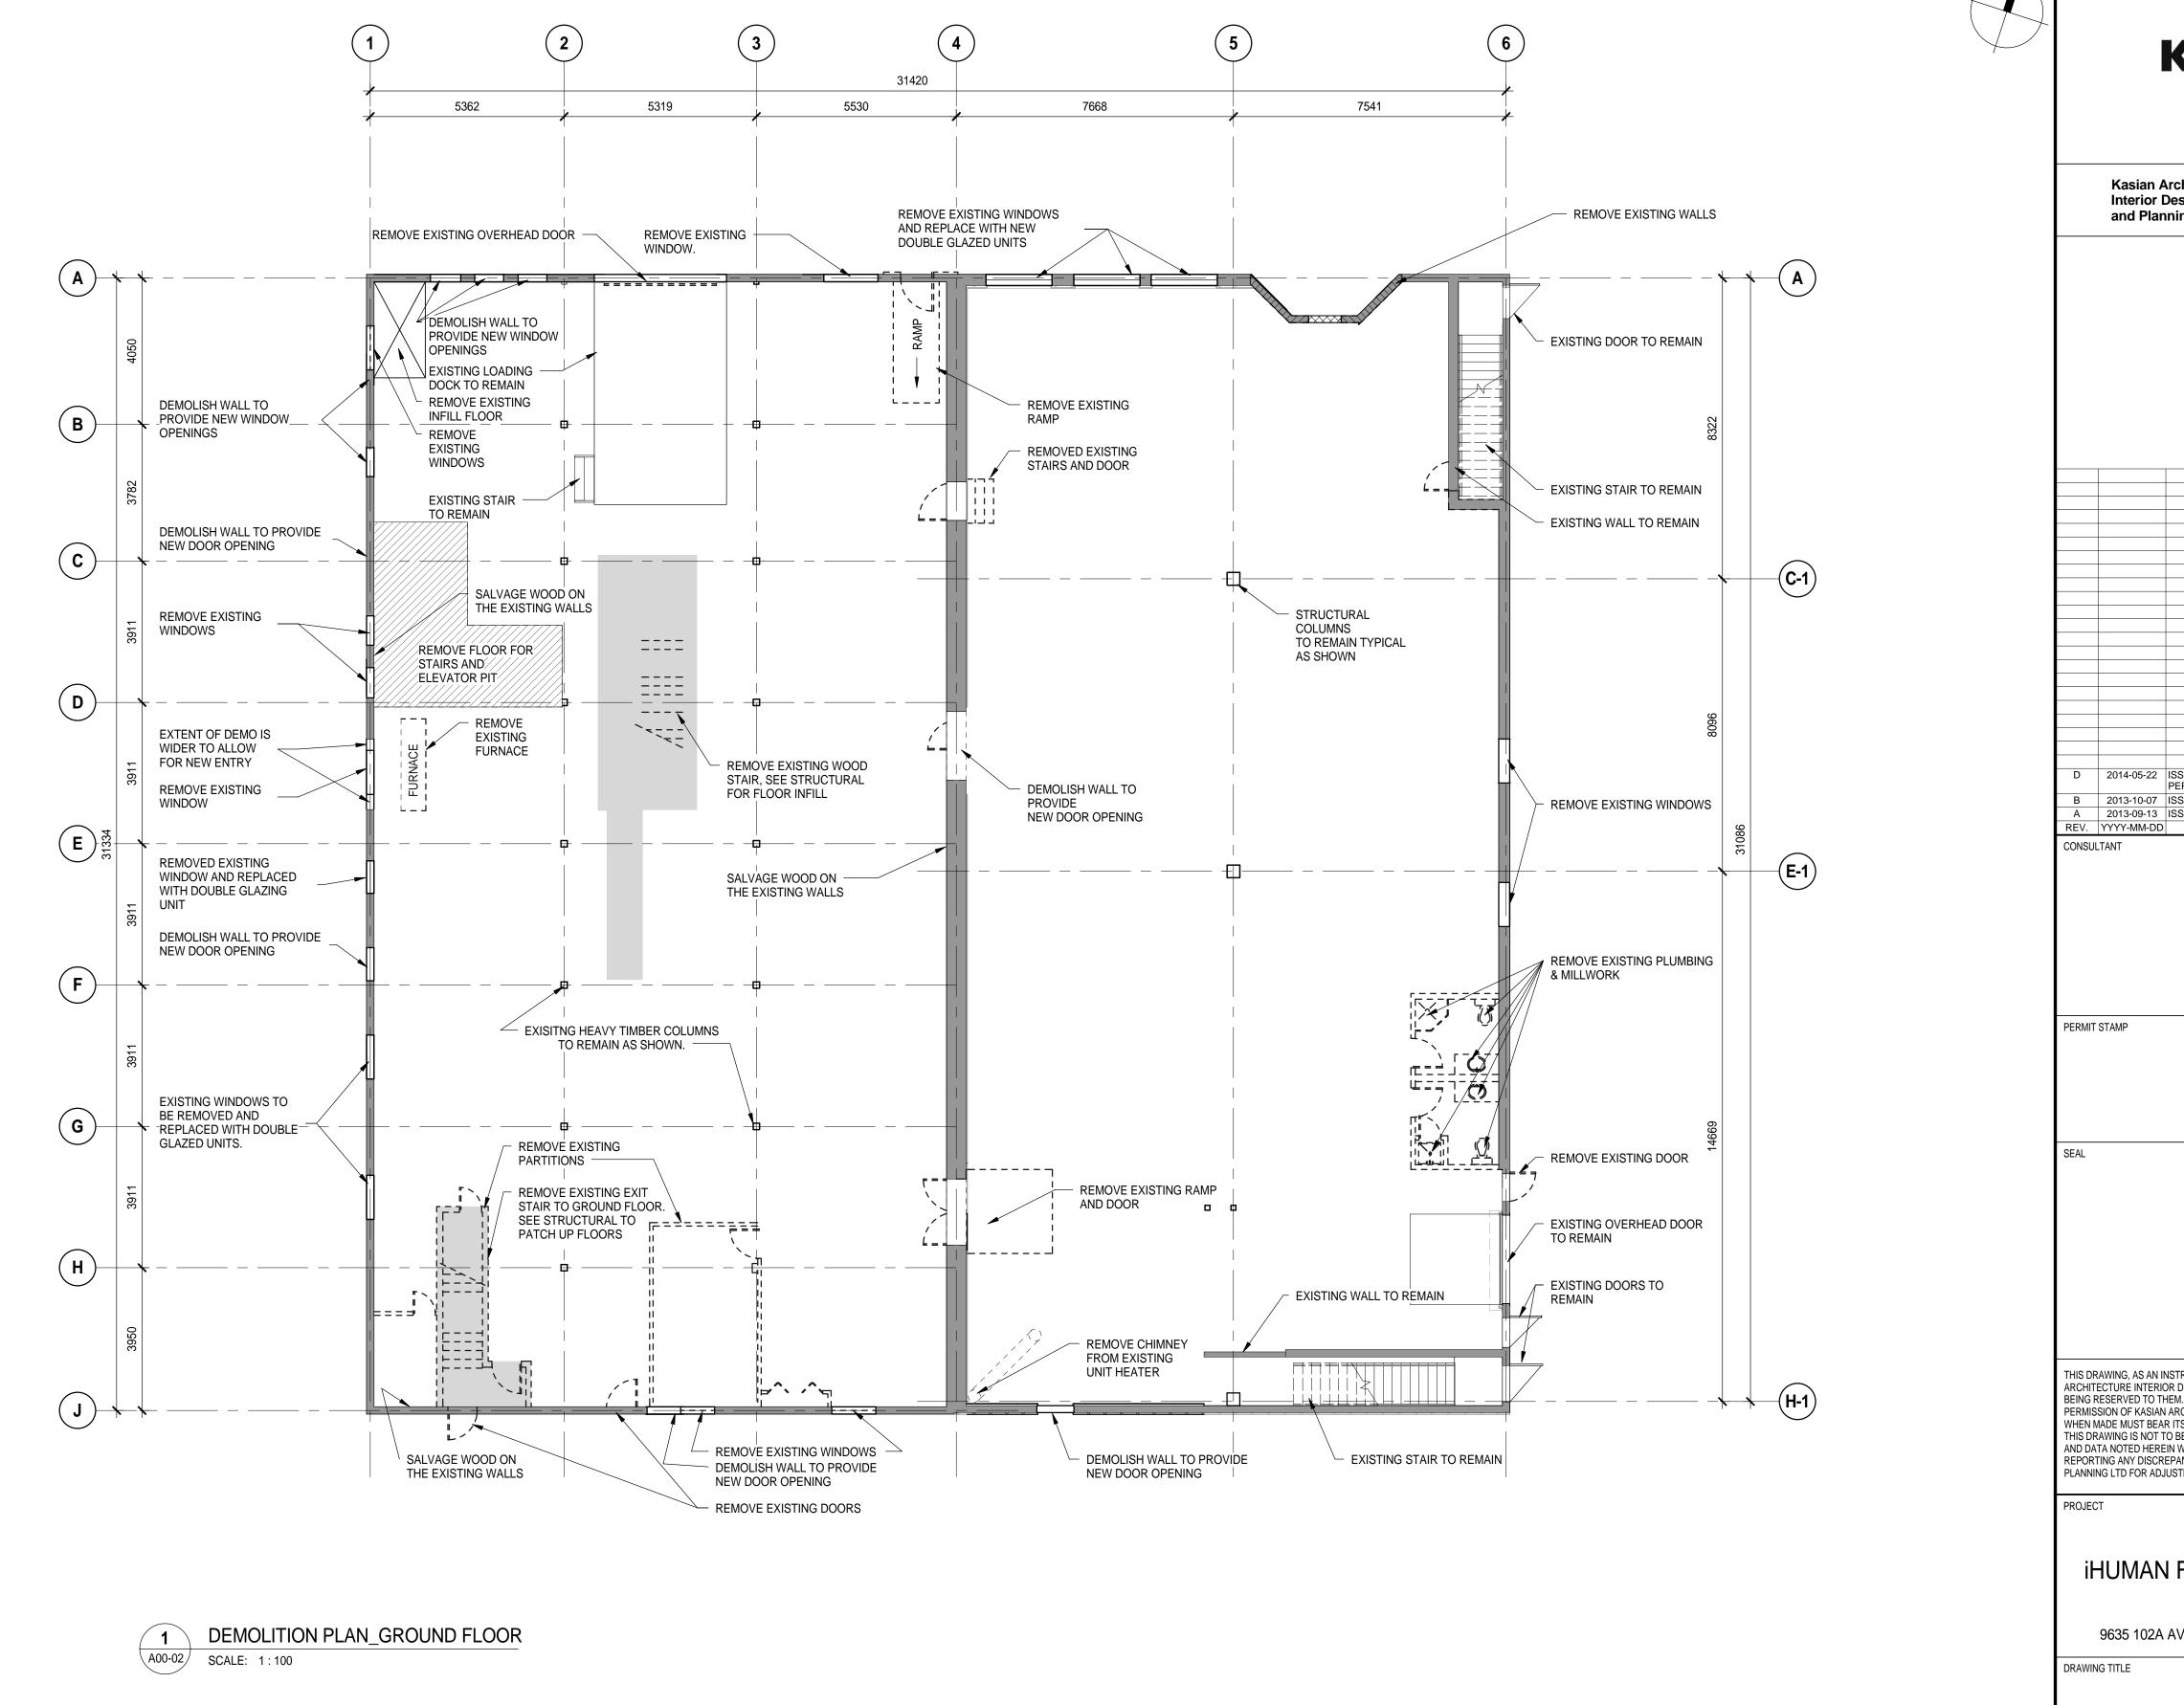
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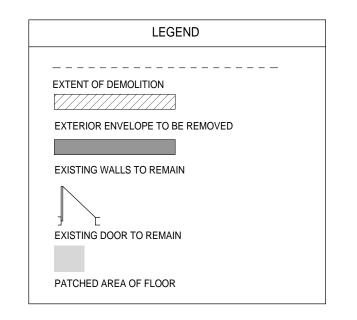
MAY 22, 2014

PLOT DATE MARCH 06, 2014

A01-01



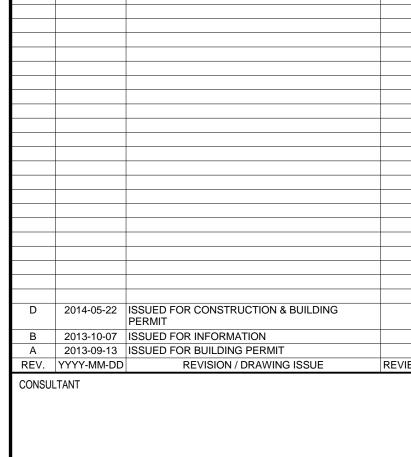






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GROUND FLOOR - EXISTING & **DEMOLITION PLAN**

DRAWING ISSUE

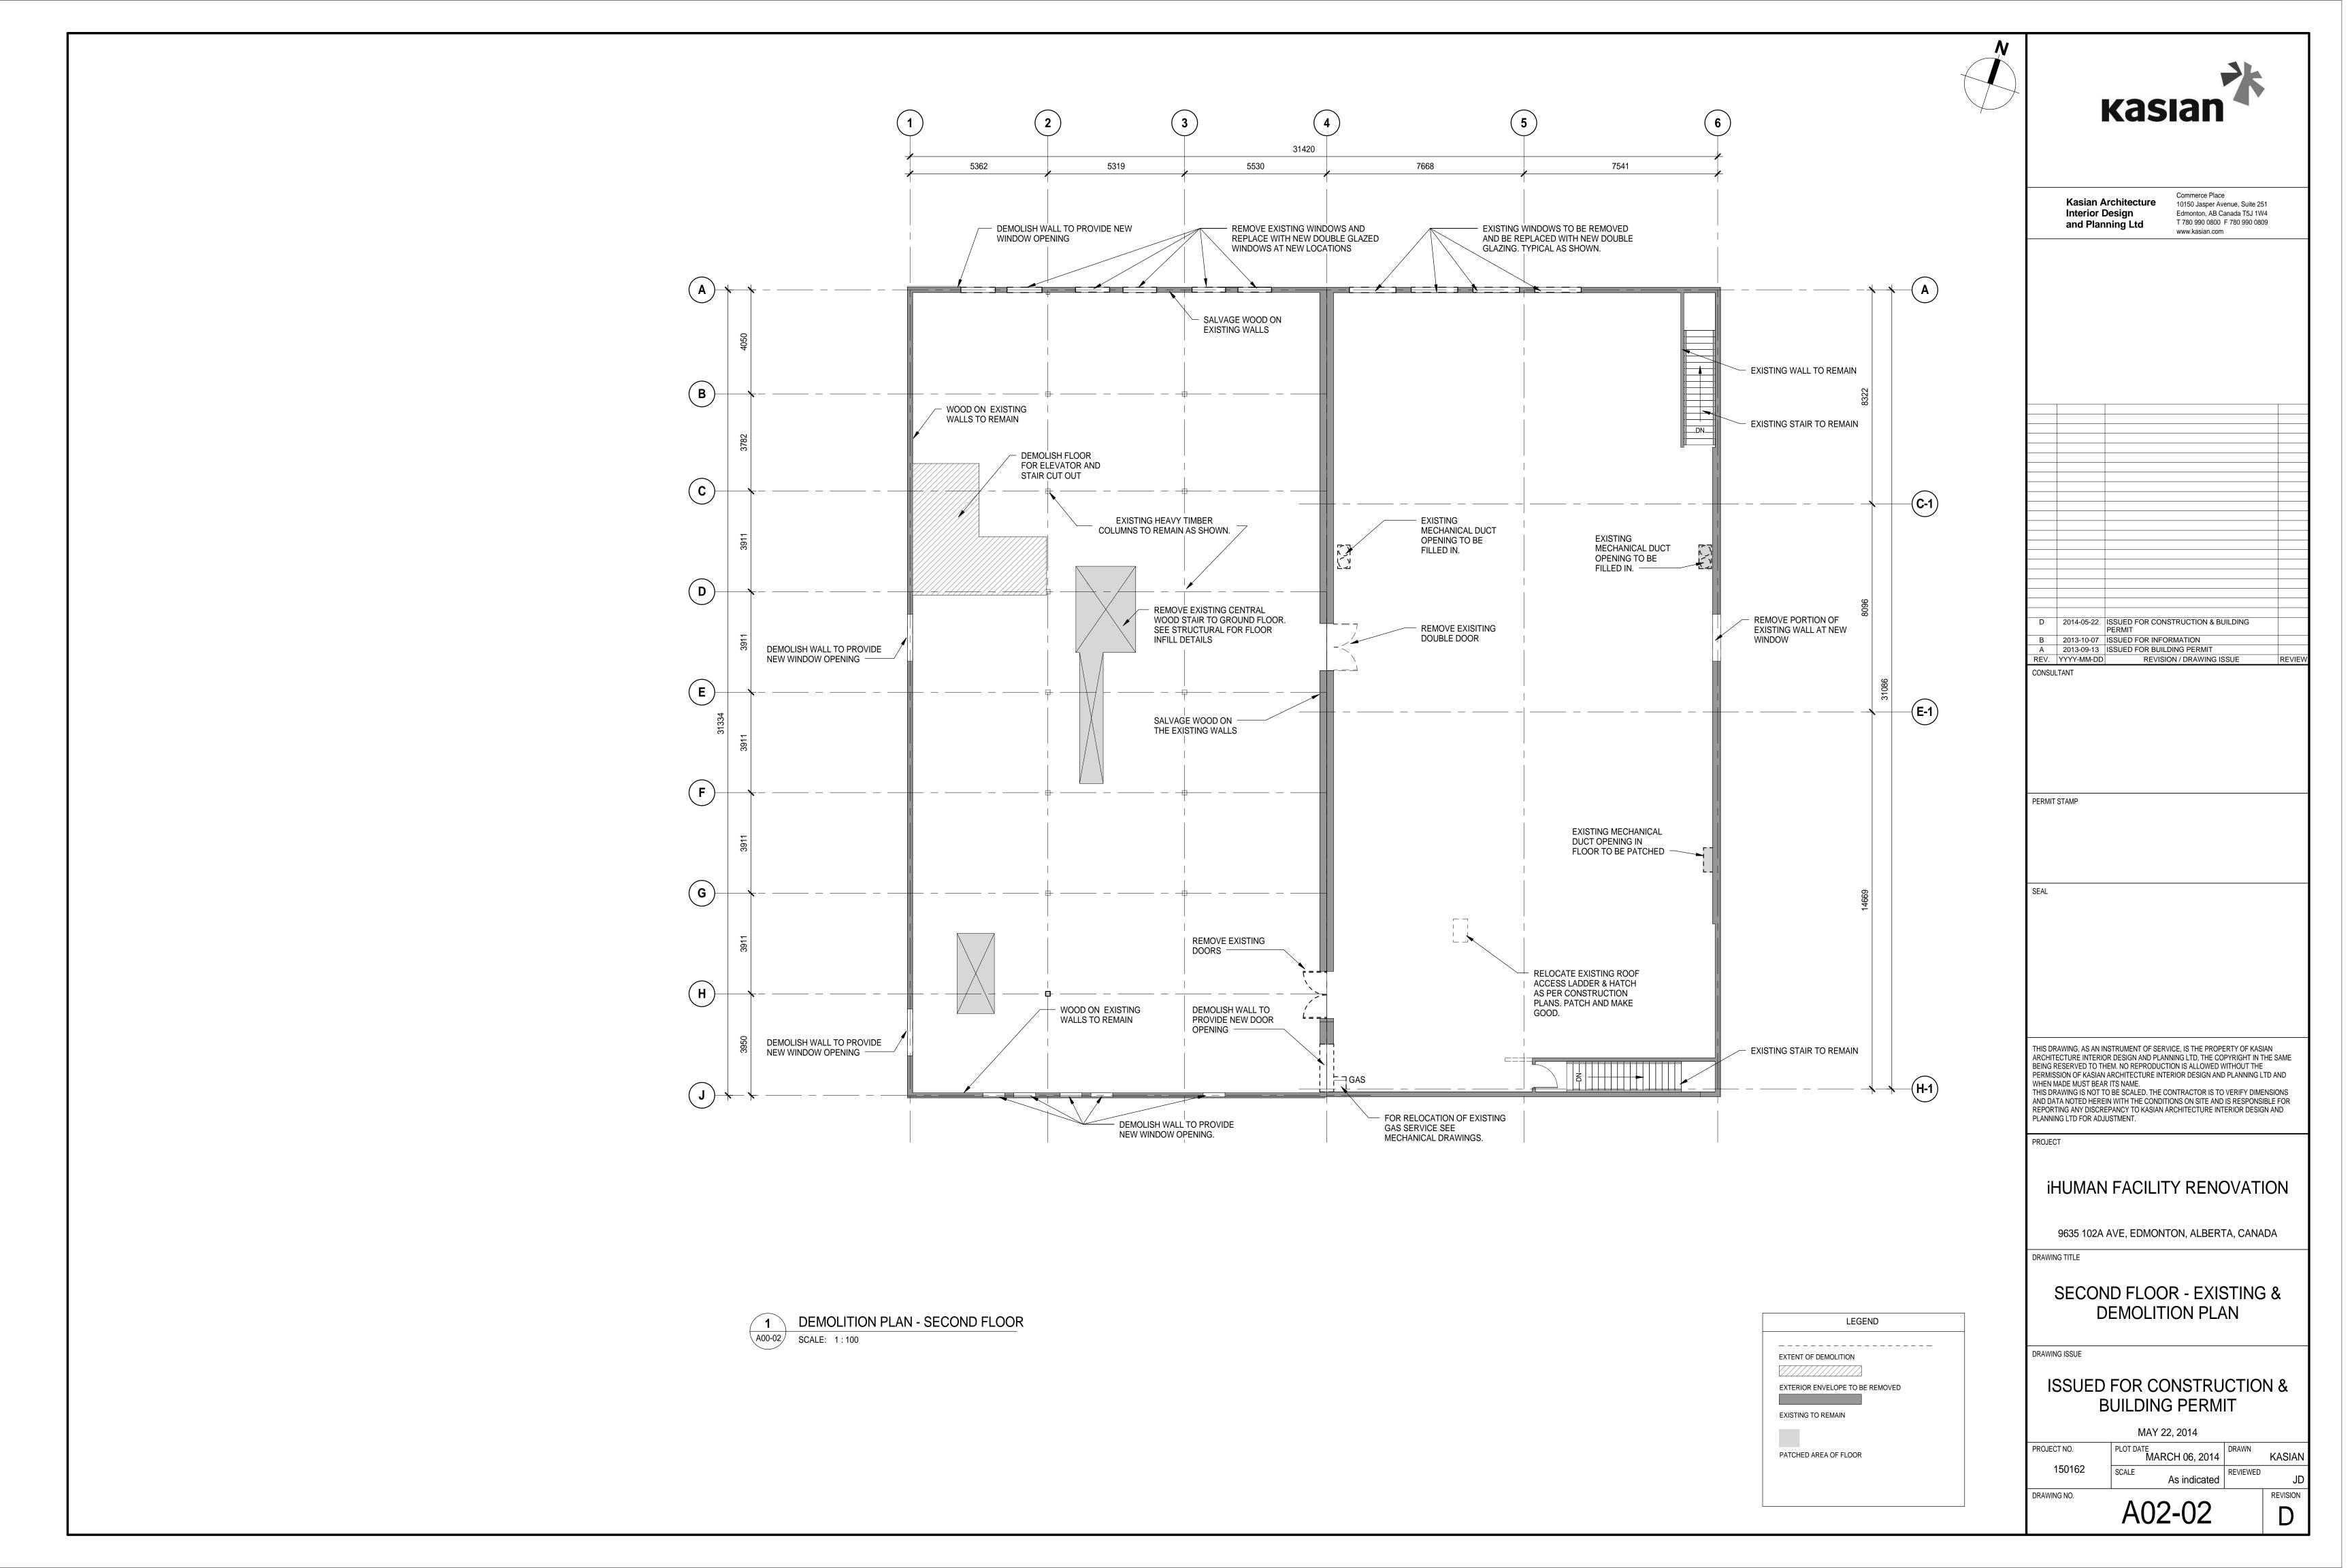
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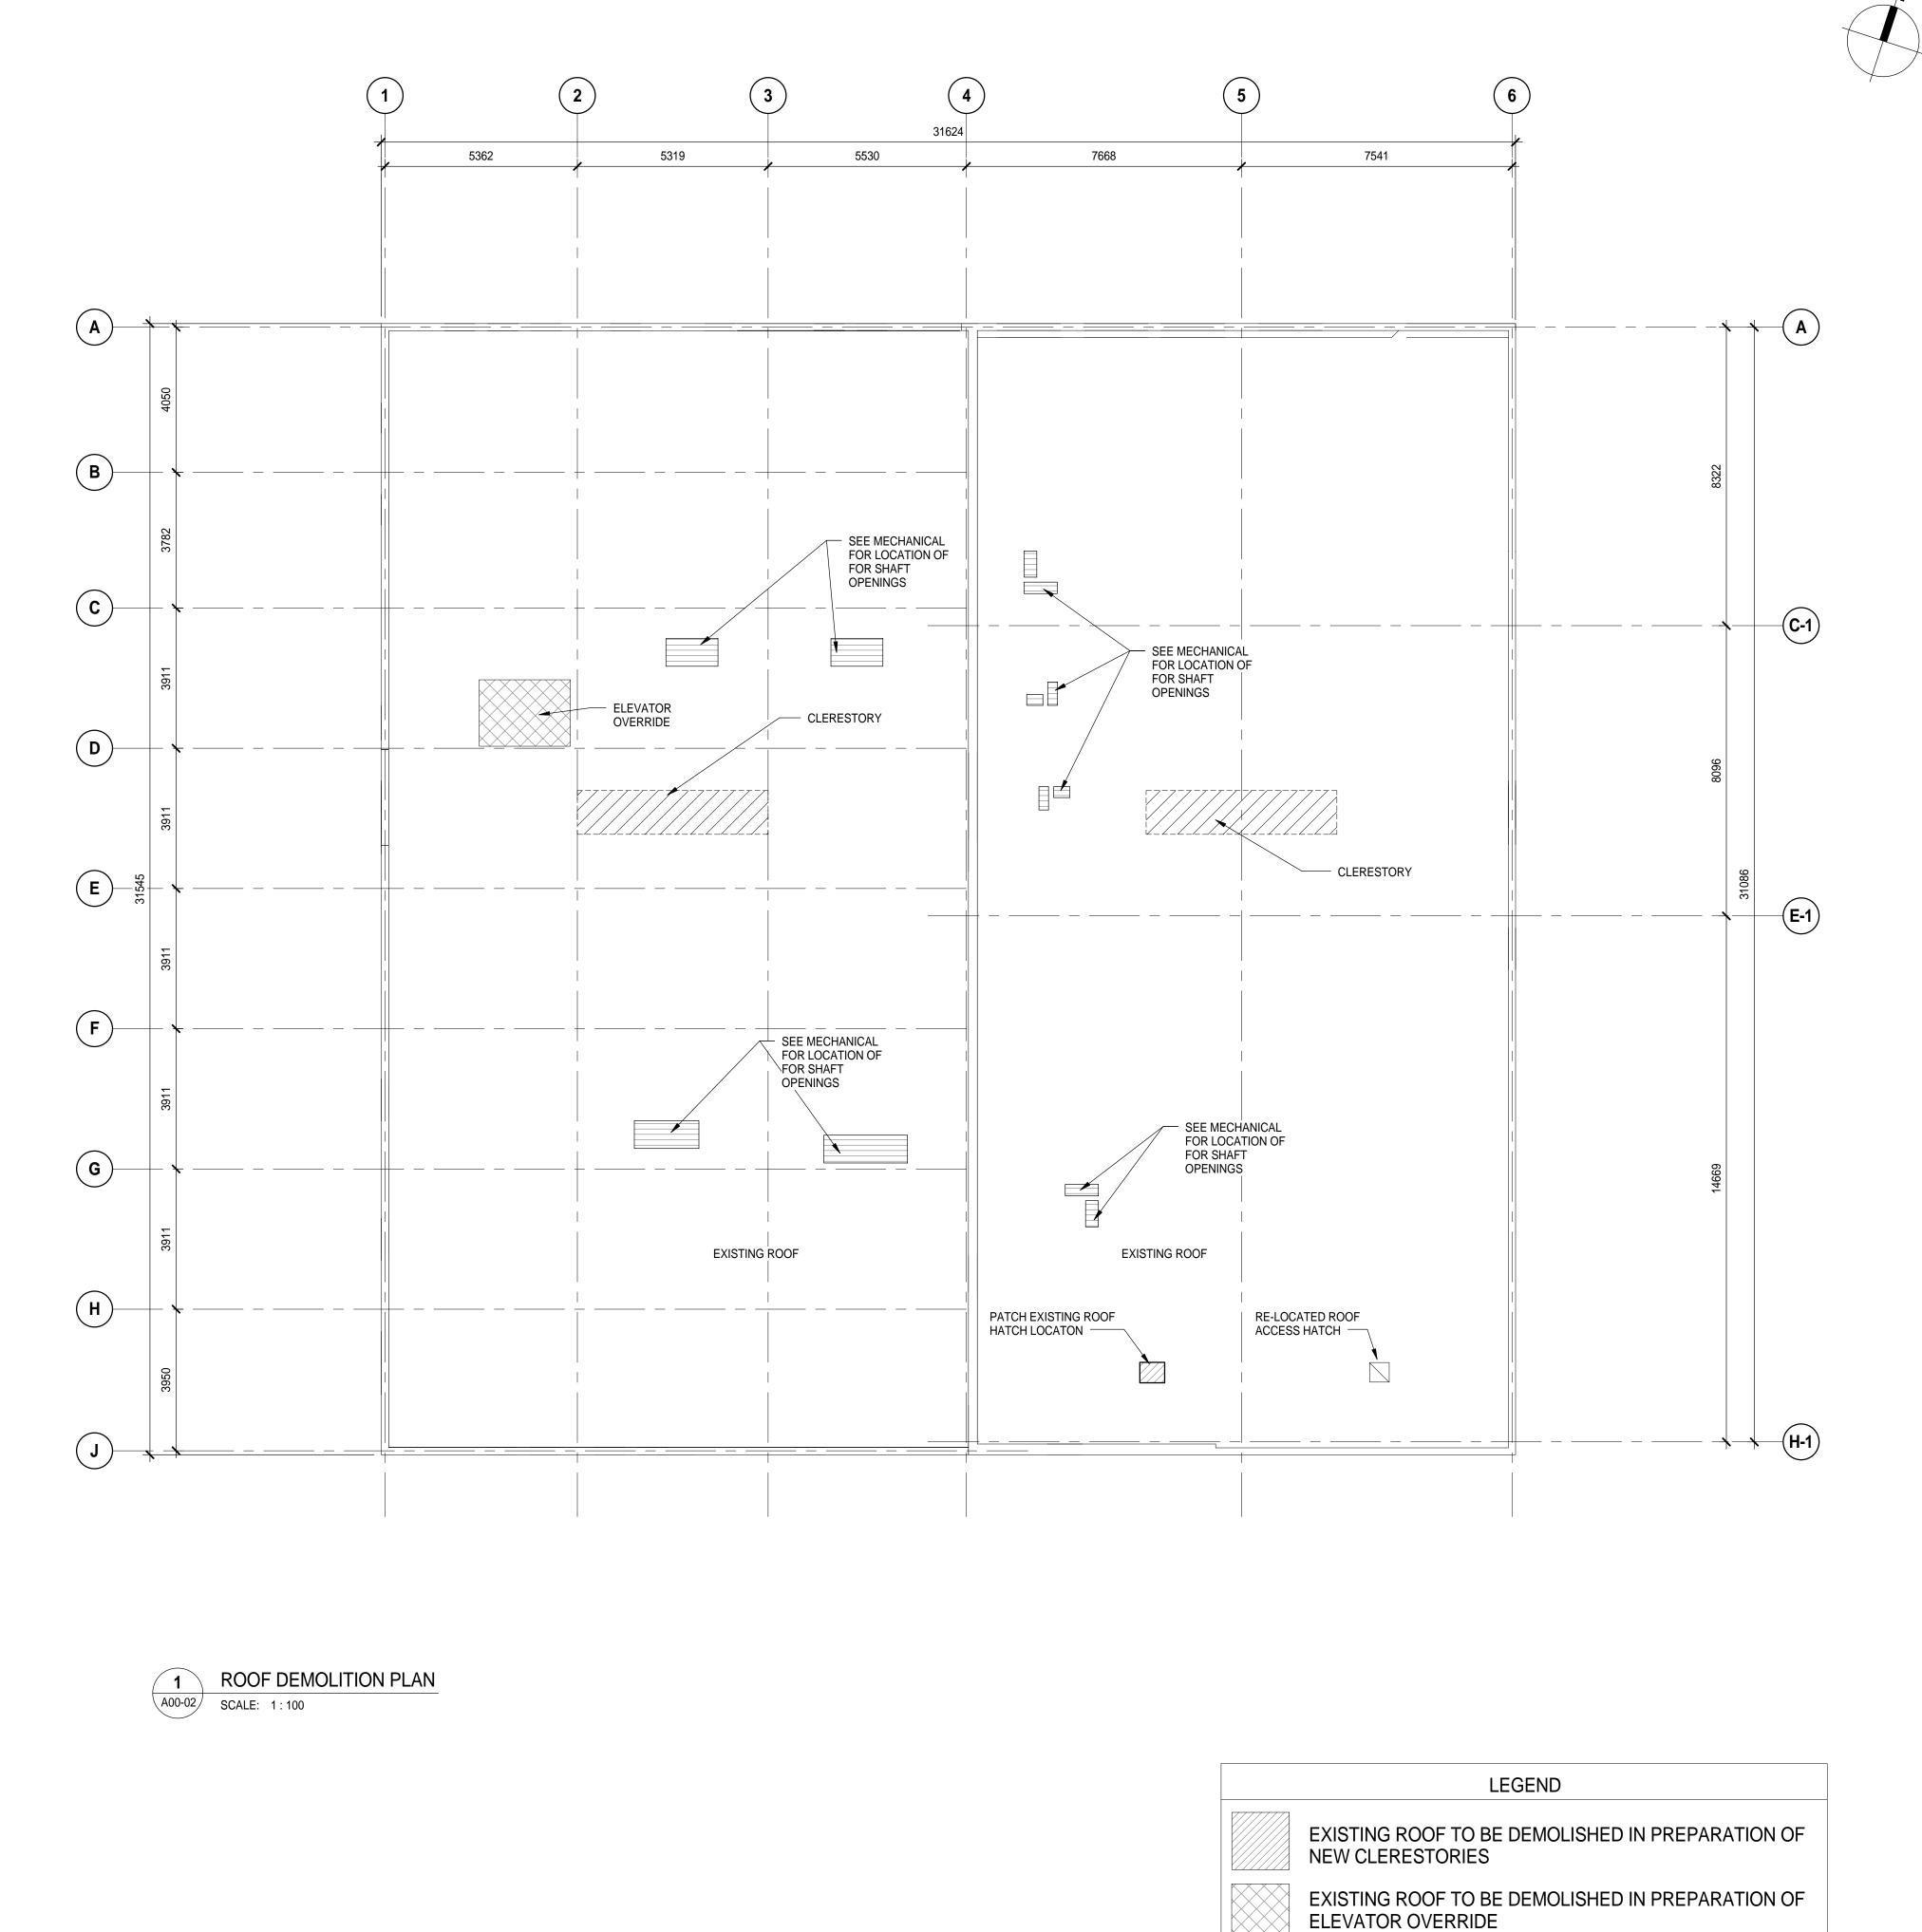
MAY 22, 2014

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PROJECT NO.	PLOT DATE MARCH 06, 2014	DRAWN	KASIAN
150162	SCALE As indicated	REVIEWED	JD
DRAWING NO.			REVISION

A02-01

REVISION





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D 2014-05-22 ISSUED FOR CONSTRUCTION & BUILDING PERMIT
B 2013-10-07 ISSUED FOR INFORMATION
A 2013-09-13 ISSUED FOR BUILDING PERMIT
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PROJECT

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9635 102A AVE, EDMONTON, ALBERTA, CANADA

DRAWING TITLE

ROOF - EXISTING & DEMOLITION PLAN

DRAWING ISSUE

EXISTING ROOF TO BE DEMOLISHED IN PREPARATION OF

NOTE: SEE STRUCTURAL FOR LOCATION AND SIZE OF DEMOLITION

ROOF TOP UNIT PENETRATIONS

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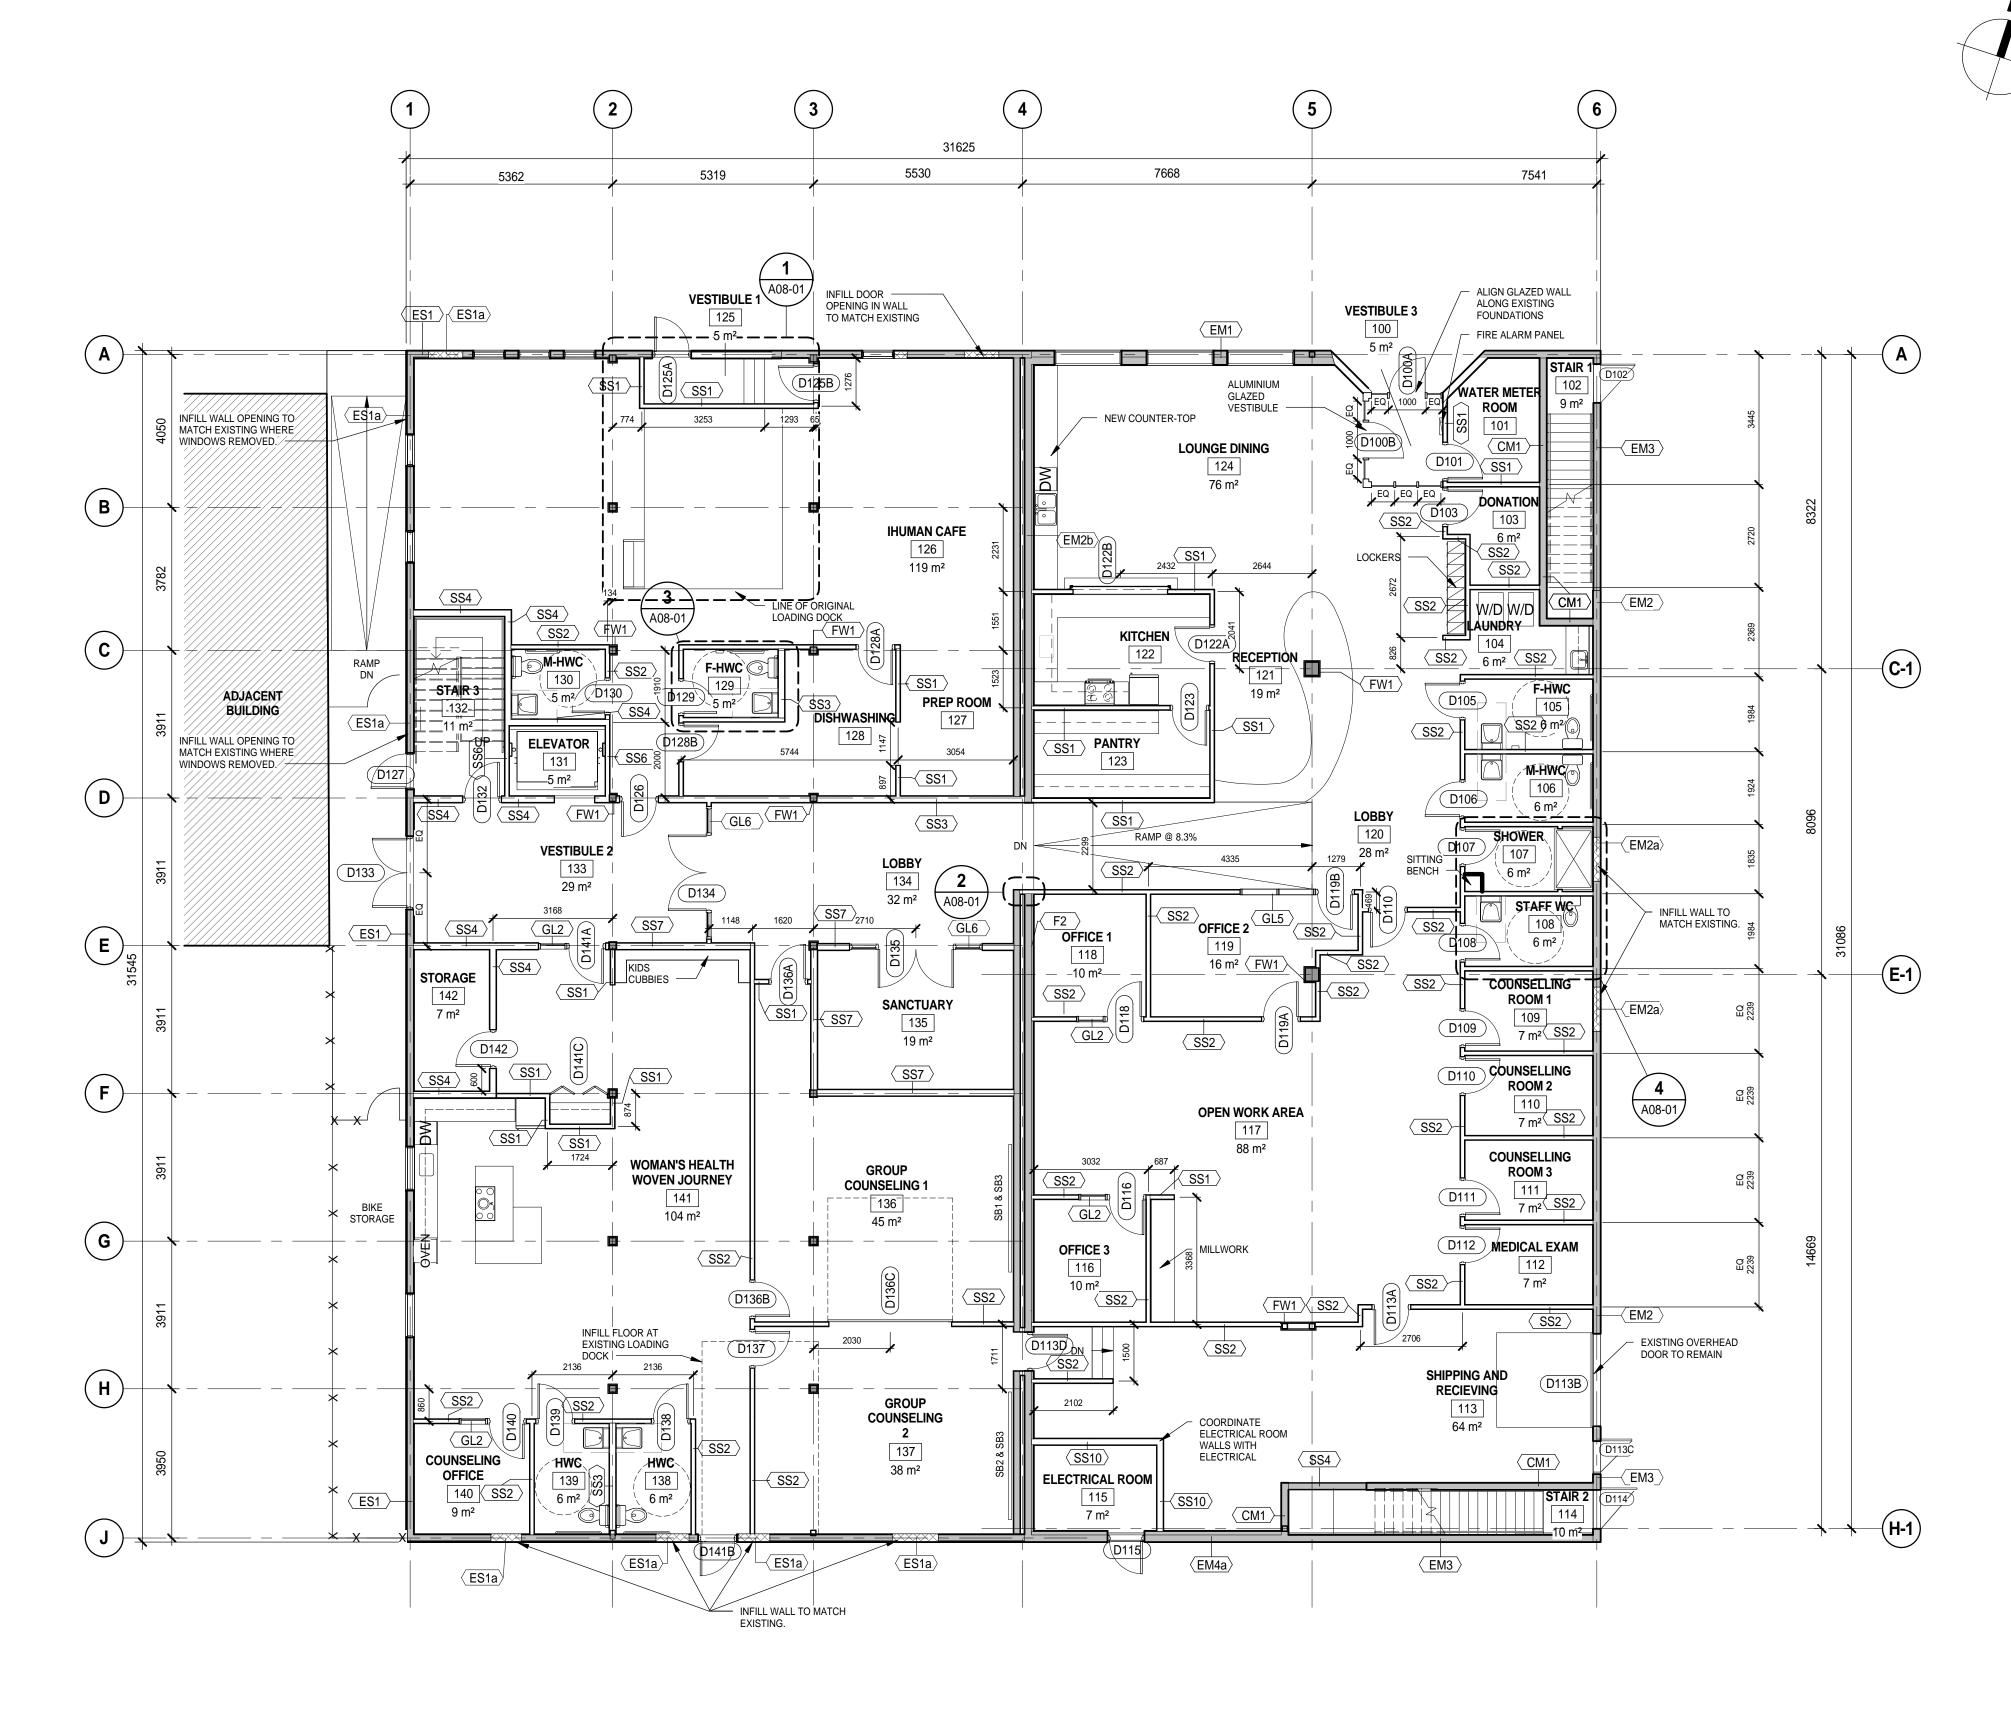
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 DRAWN
 KASIAN

 150162
 SCALE
 1:100
 REVIEWED
 JD

 DRAWING NO.
 REVISION

A02-03



GENERAL WC HARDWARE NOTES

ALL MALE W/C's COMPLETE WITH THE FOLLOWING HARDWARE: TISSUE DISPENSER, SOAP DISPENSER, COAT HOOK PER TOILET DOOR, AND PAPER TOWEL DISPENSER & WASTE RECEPTACLE.

ALL **FEMALE W/C's** COMPLETE WITH THE FOLLOWING HARDWARE: TISSUE DISPENSER, SOAP DISPENSER, SANITARY NAPKIN DISPOSAL, COAT HOOK PER TOILET DOOR, AND PAPER TOWEL DISPENSER & WASTE RECEPTACLE.

ALL HANDICAP W/C's COMPLETE WITH THE FOLLOWING HARDWARE: TISSUE DISPENSER, SOAP DISPENSER, SANITARY NAPKIN DISPOSAL, PAPER TOWEL

DISPENSER & WASTE RECEPTACLE, COAT HOOK PER TOILET DOOR, AND TWO GRAB BARS. ENSURE LAVARATORY MILLWORK DIMENSIONS AND HEIGHT, AND DOOR

HARDWARE AS PER BARRIER FREE STANDARD. COMPLY WITH ALL BARRIER FREE

REQUIREMENTS AS SPECIFIED IN THE 2008 ALBERTA BARRIER FREE DESIGN GUIDE.

GROUND FLOOR PLAN SCALE: 1:100

1.) ALL INTERIOR DRYWALL SURFACES TO BE PAINTED, COLOR TO BE DETERMINED

2.) ALL WASHROOM INTERIOR WALLS TO BE TILED

3.) ALL EXISTING CMU EXTERIOR TO BE PAINTED, COLOR TO BE DETERMINED 4.) DIFFERING STUCCO CONDITIONS - MATCH TO EXISTING 5.) WOOD BUILDING FLOORING - ALL EXISTING WOOD FLOORING TO BE REFINISHED WF

FLOOR FINISHES

CARPET TILE PT PORCELAIN FLOOR TILE UN UNFINISHED VF VINYL FLOORING WOOD FLOORING

NEW WALL EXISTING NEW DOOR DOOR TO REMAIN EXTINGUISHER

PATCHED AREA OF FLOOR

EXISTING TO REMAIN

NEW GLAZING

LEGEND

AD - ACCORDION DOOR FOR SPECIFICATION SB1, SB2, SB3 - SMART

CG1 - CORNER GUARD 1

REFER TO COLOUR AND

FINISHES SPECIFICATION

CG2 - CORNER GUARD 2

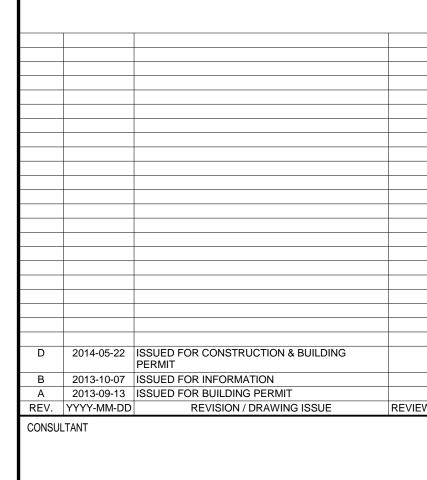
REFER TO COLOUR AND

FINISHES SPECIFICATION

REFER TO DOOR SCHEDULE BOARD REFER TO COLOUR AND FINISHES SPECIFICATION



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DRAWING TITLE

GROUND FLOOR - CONSTRUCTION PLAN

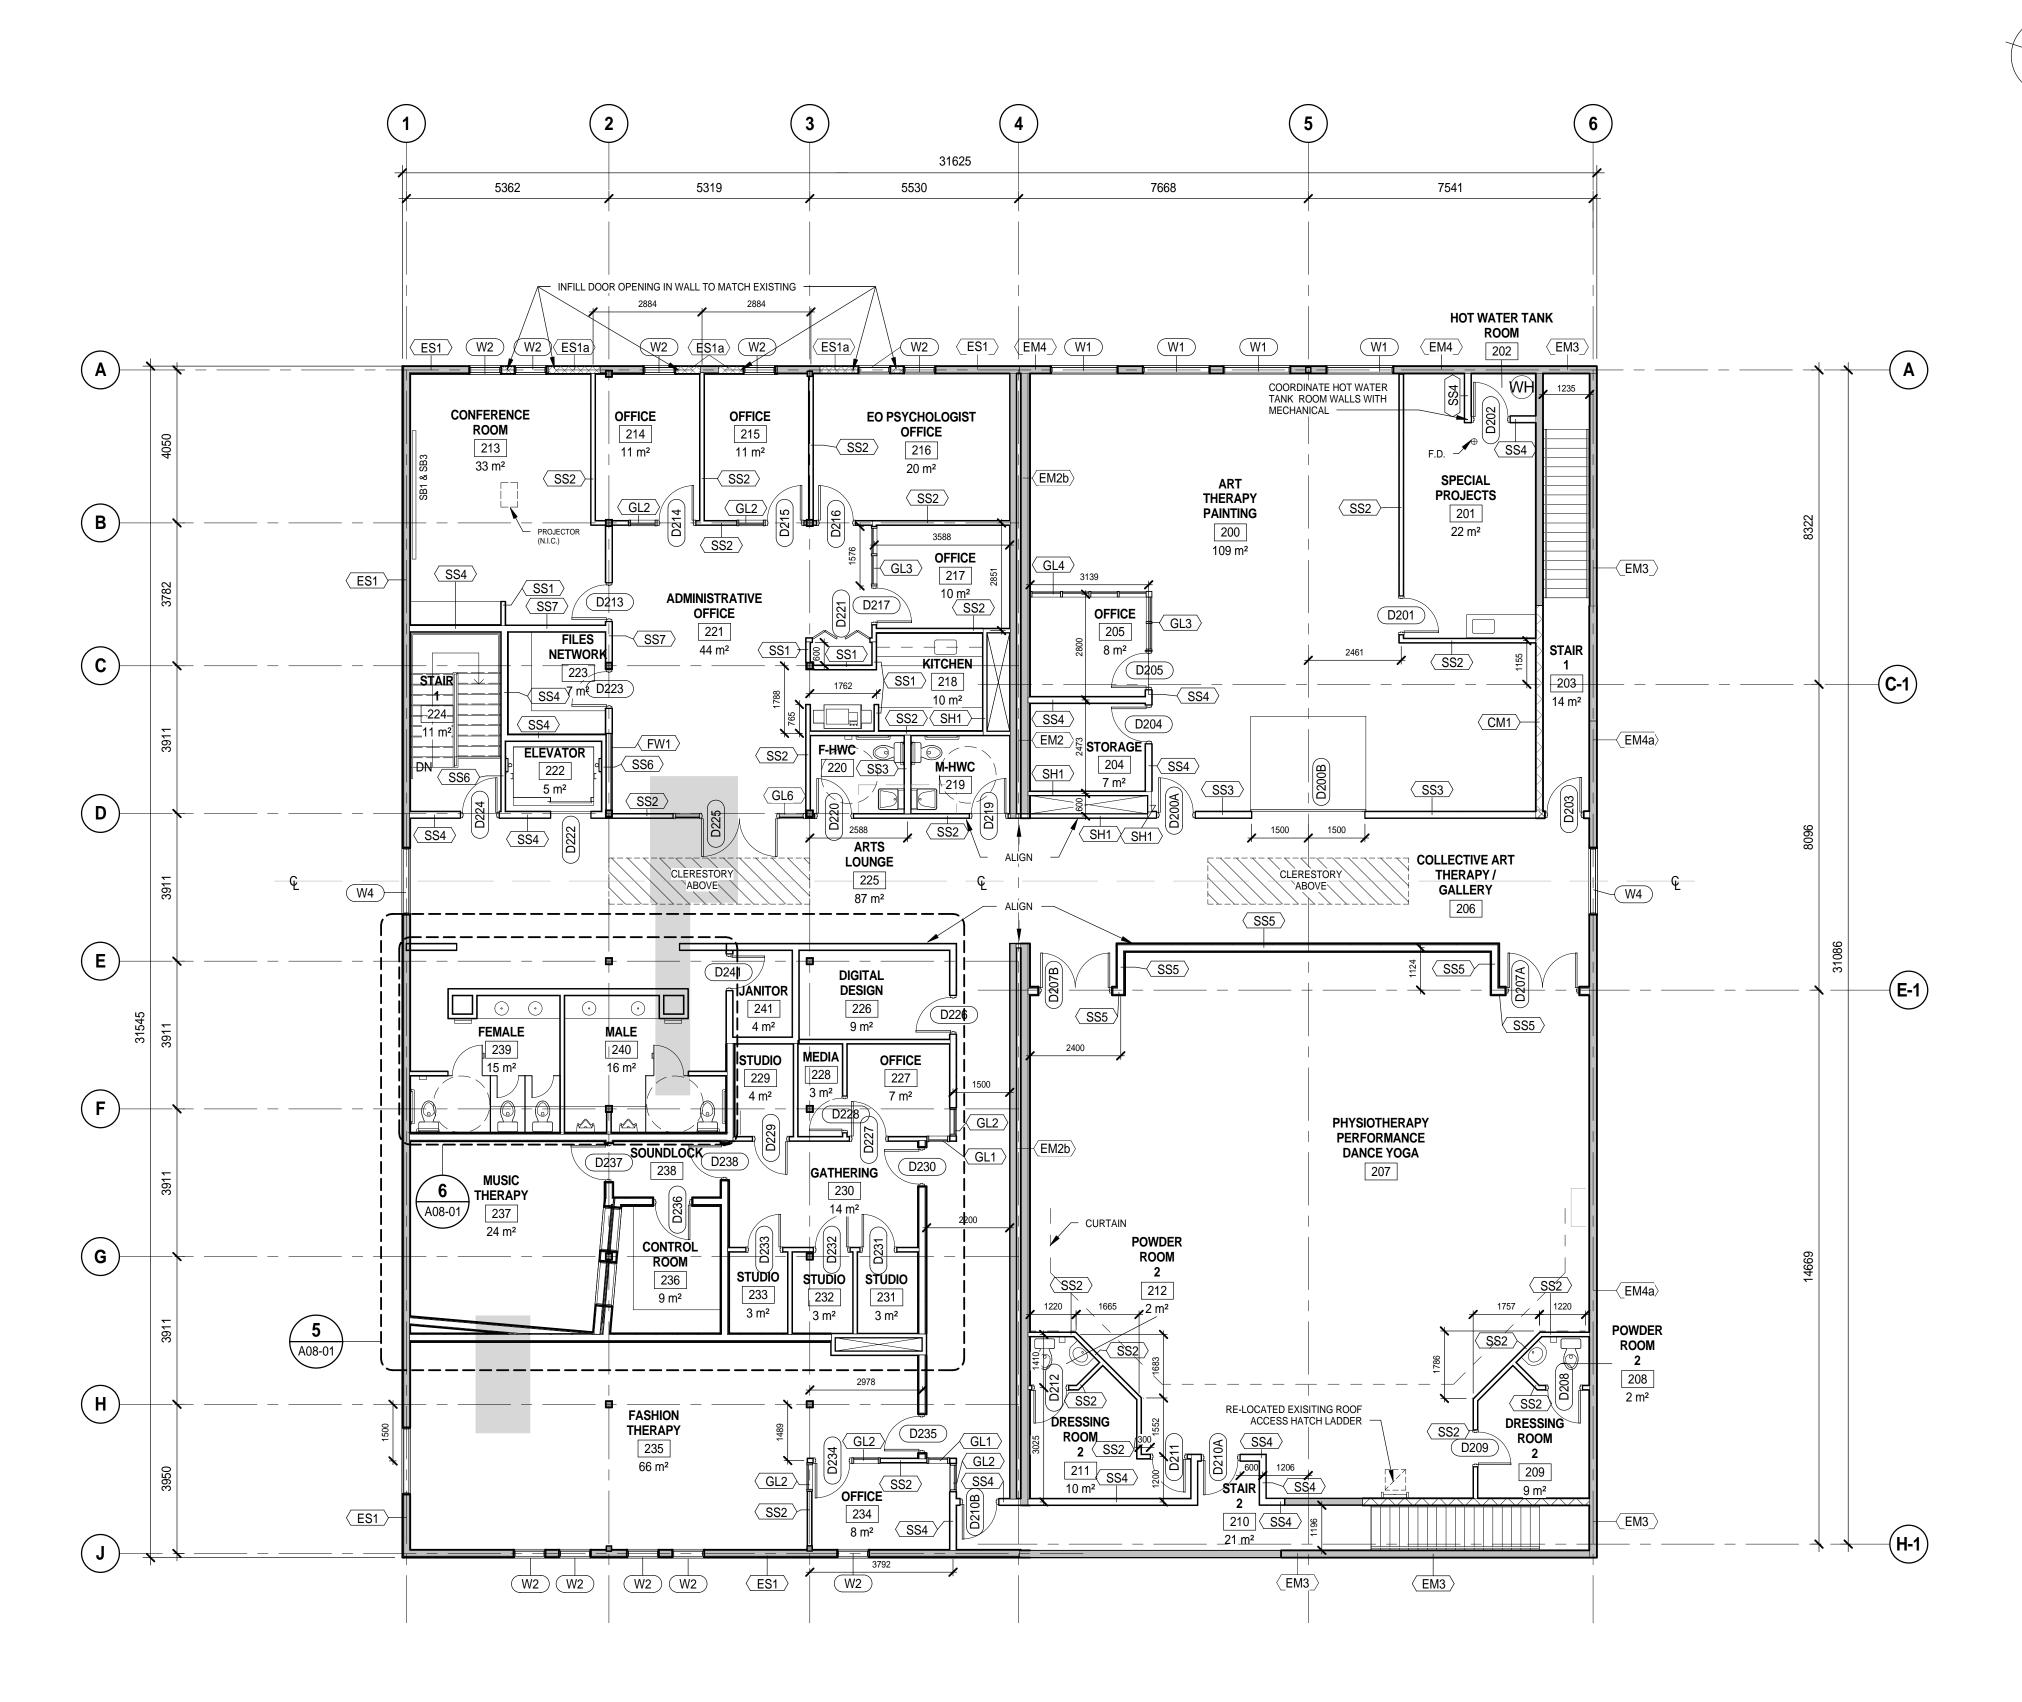
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A02-10



GENERAL WC HARDWARE NOTES

ALL MALE W/C's COMPLETE WITH THE FOLLOWING HARDWARE: TISSUE DISPENSER, SOAP DISPENSER, COAT HOOK PER TOILET DOOR, AND PAPER TOWEL DISPENSER & WASTE RECEPTACLE.

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ALL **HANDICAP W/C's** COMPLETE WITH THE FOLLOWING HARDWARE: TISSUE DISPENSER, SOAP DISPENSER, SANITARY NAPKIN DISPOSAL, PAPER TOWEL DISPENSER & WASTE RECEPTACLE, COAT HOOK PER TOILET DOOR, AND TWO GRAB BARS. ENSURE LAVARATORY MILLWORK DIMENSIONS AND HEIGHT, AND DOOR HARDWARE AS PER BARRIER FREE STANDARD. COMPLY WITH ALL BARRIER FREE REQUIREMENTS AS SPECIFIED IN THE 2008 ALBERTA BARRIER FREE DESIGN GUIDE.

SECOND FLOOR PLAN A00-02 SCALE: 1:100

1.) ALL INTERIOR DRYWALL SURFACES TO BE PAINTED, COLOR TO BE DETERMINED

2.) ALL WASHROOM INTERIOR WALLS TO BE TILED

3.) ALL EXISTING CMU EXTERIOR TO BE PAINTED, COLOR TO BE DETERMINED

4.) DIFFERING STUCCO CONDITIONS - MATCH TO EXISTING

5.) WOOD BUILDING FLOORING - ALL EXISTING WOOD FLOORING TO BE REFINISHED

EXISTING TO REMAIN **NEW GLAZING NEW WALL** EXISTING NEW DOOR

REFER TO COLOUR AND FINISHES SPECIFICATION

LEGEND

DOOR TO REMAIN FIRE F EXTINGUISHER

PATCHED AREA OF FLOOR

AD - ACCORDION DOOR REFER TO DOOR SCHEDULE FOR SPECIFICATION SB1, SB2, SB3 - SMART BOARD REFER TO COLOUR AND

FINISHES SPECIFICATION

CG1 - CORNER GUARD 1

REFER TO COLOUR AND

FINISHES SPECIFICATION

CG2 - CORNER GUARD 2



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SECOND FLOOR - CONSTRUCTION PLAN

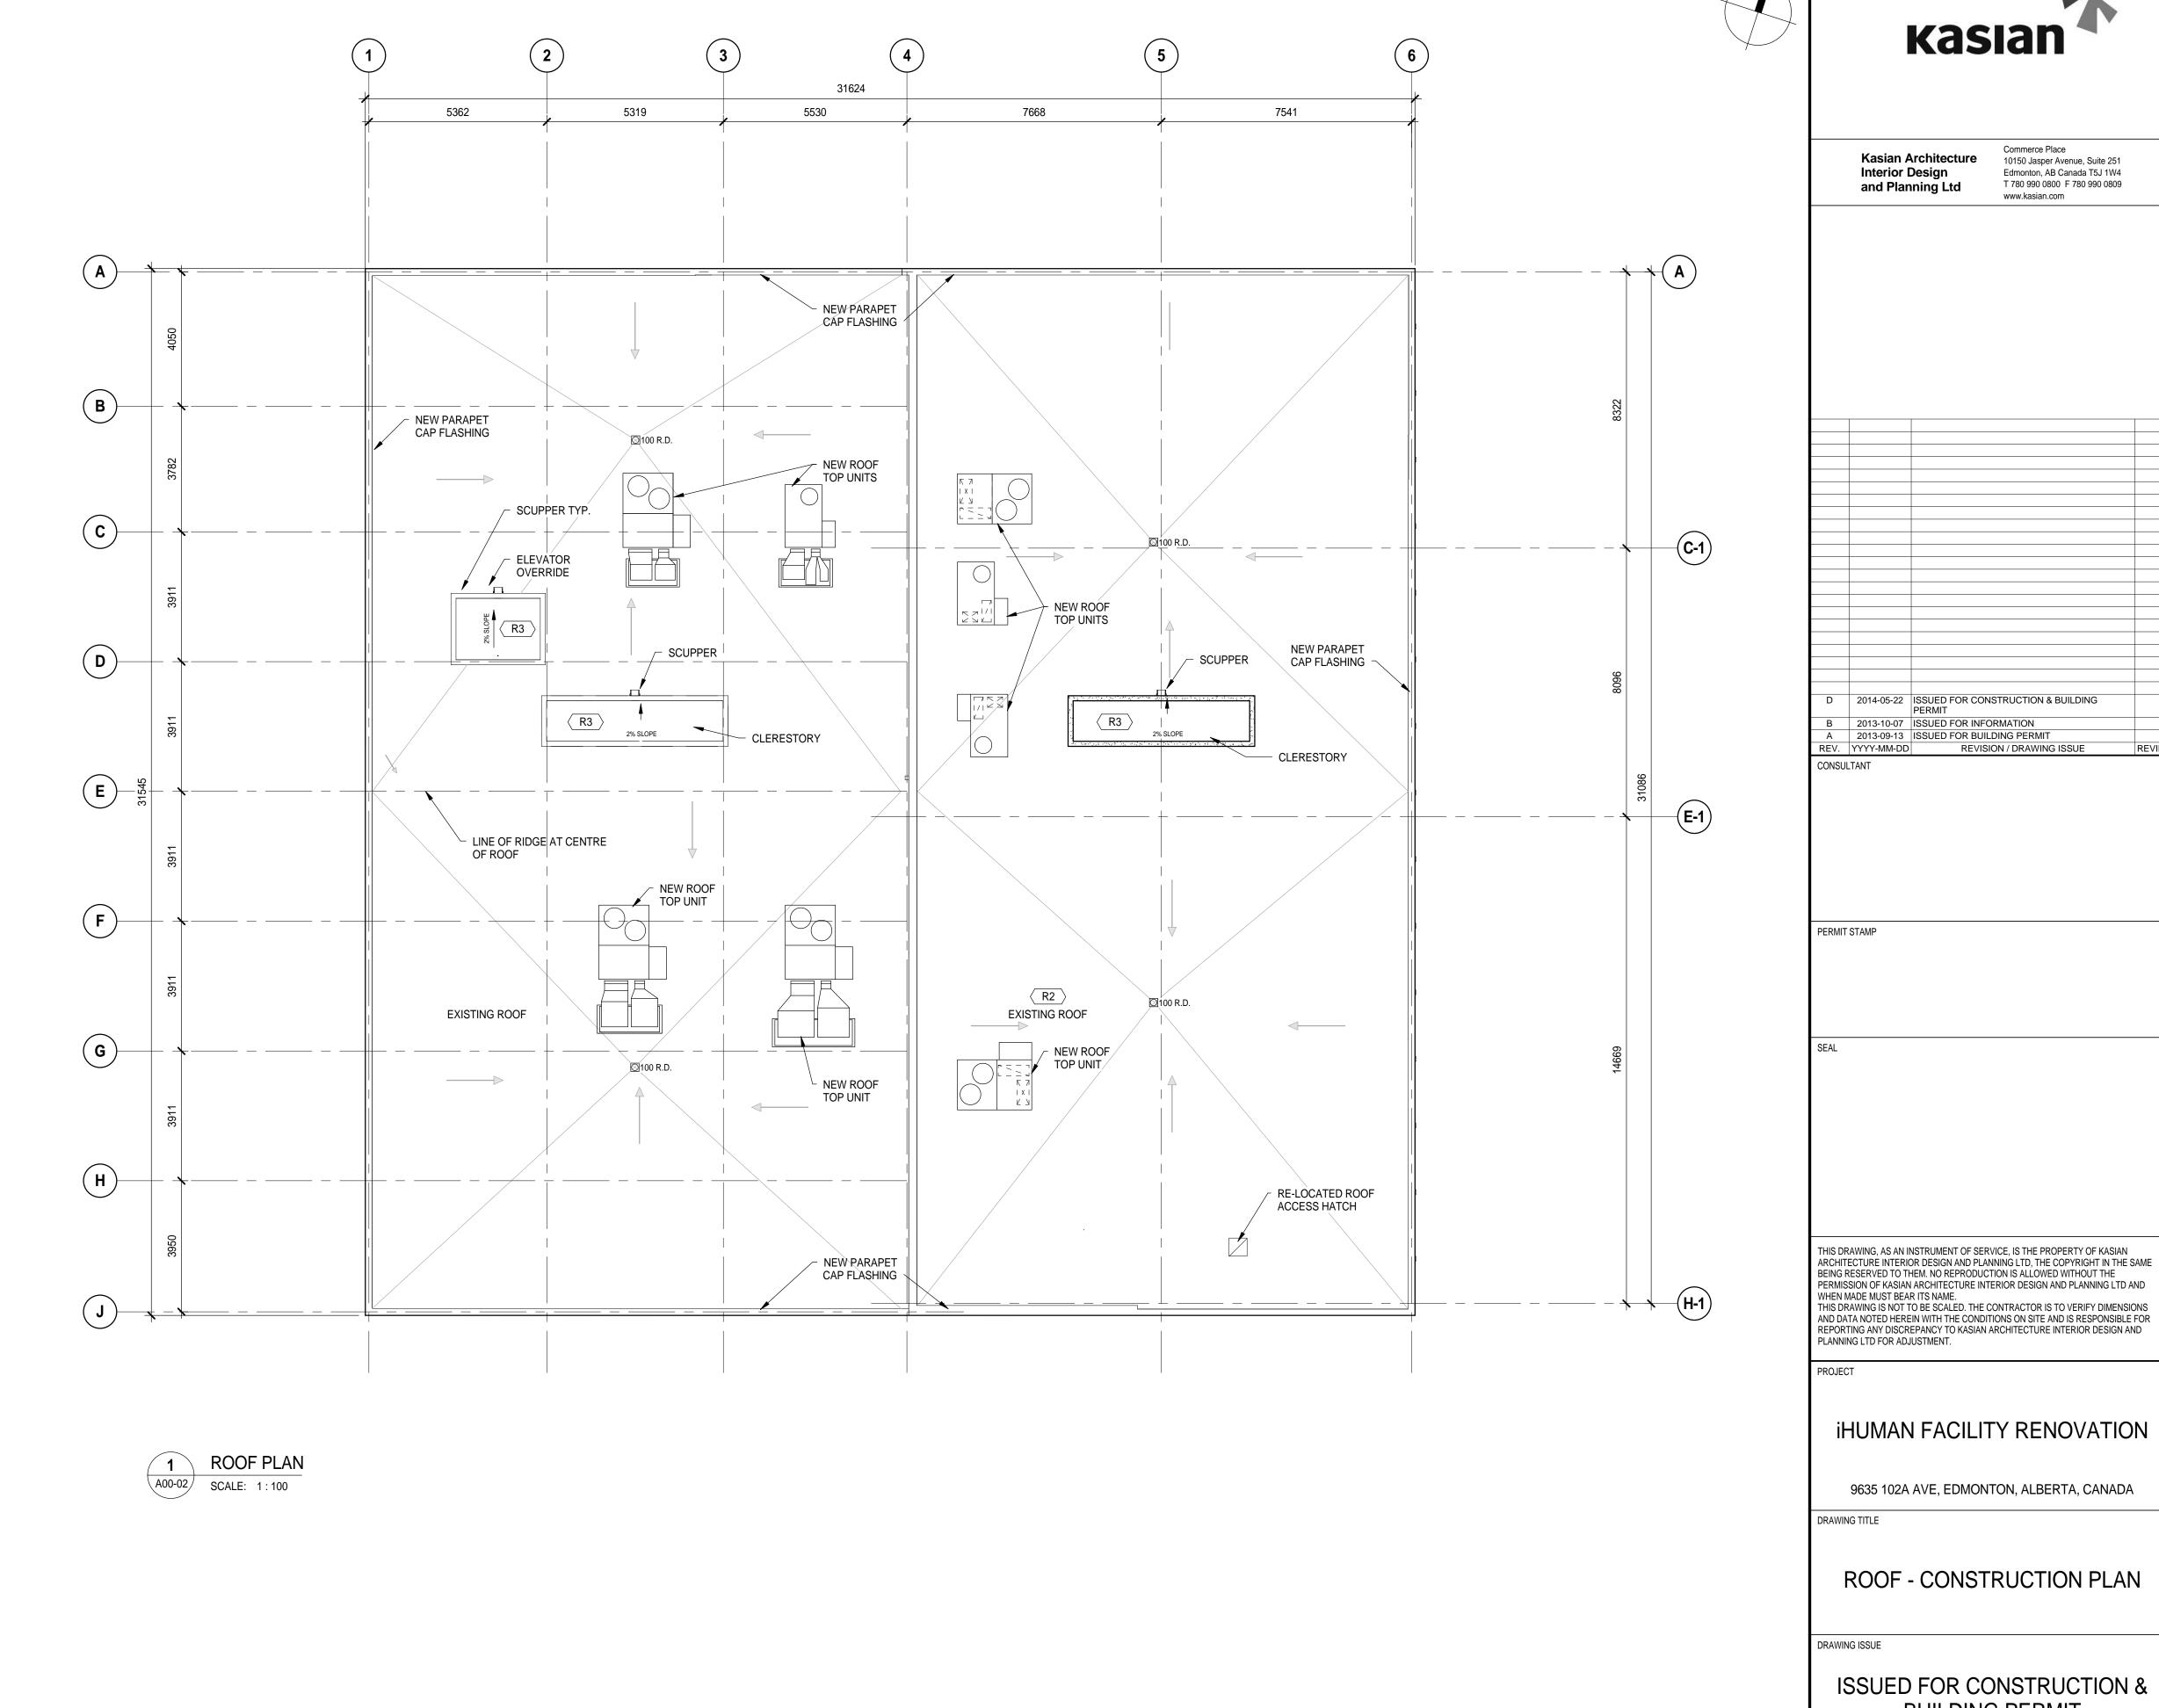
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ROOF - CONSTRUCTION PLAN

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PLOT DATE MARCH 06, 2014 DRAWN KASIAN 1:100 REVIEWED 150162 SCALE DRAWING NO.

A02-12

REVISION

